# ORANGEVALE COMMUNITY CENTER NEW PARKING LOT CONNECTION

ORANGEVALE, CALIFORNIA

# PROJECT APPLICANT:

ORANGEVALE RECREATION AND PARK DISTRICT 6826 HAZEL AVENUE, ORANGEVALE, CA 95662 ph: (916) 988-4373

LANDSCAPE ARCHITECT
MTW GROUP
PETER LARIMER
2707 K STREET, SUITE 201
SACRAMENTO, CA 95816
916-369-3990


CIVIL ENGINEER
WARREN CONSULTING ENGINEERS
MARTY GEE
1117 WINDFIELD WAY, SUITE 100
EL DORADO HILLS, CA 95762
916-985-1870


THE OWNER, APPLICANT, OR REPRESENTATIVE MUST REPRODUCE AND DELIVER THREE (3) PLAN SETS TO SACRAMENTO COUNTY'S CONSTRUCTION MANAGEMENT AND INSPECTION DIVISION (CMID) LOCATED AT 9700 GOETHE ROAD SUITE "D" SACRAMENTO, CA 95827. A PRE-CONSTRUCTION CONFERENCE IS MANDATORY PRIOR TO COMMENCING IMPROVEMENTS. CONTACT CMID - JEFF TERNES (916) 875-2760.

# SHEET INDEX

CVR COVERSHEET
L0.1 SITE DEMOLITION PLAN
L1.1 OVERALL SITE PLAN
L1.2 ROADWAY ENLARGEMENT
L2.1 CONSTRUCTION DETAILS

CO.1 CIVIL COVER SHEET
CO.2 STANDARD NOTES
C1.1 TOPOGRAPHIC SURVEY
C2.1 GRADING PLAN
C3.1 EROSION CONTROL PLAN

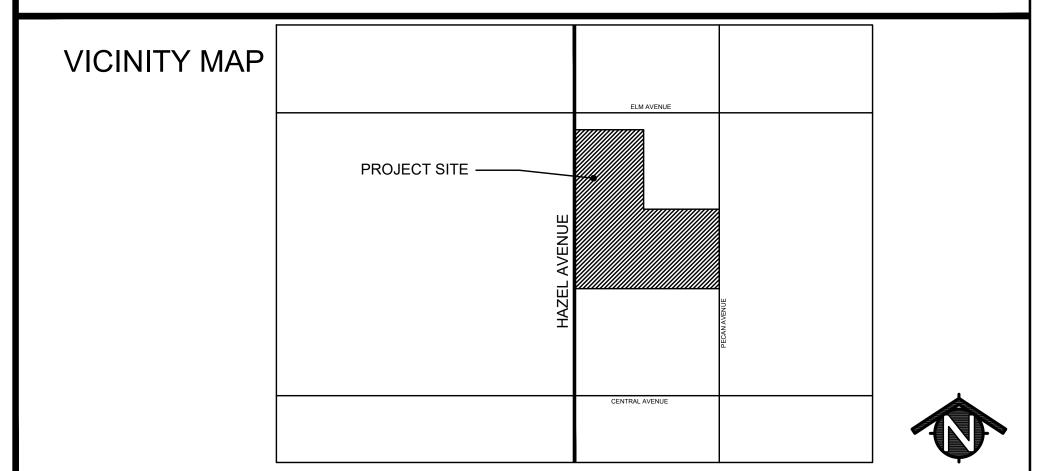

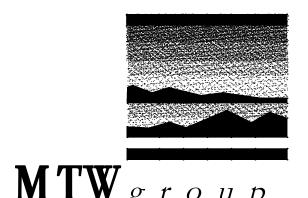

LANDSCAPE ARCHITECTURE
AND PLANNING


2707 K STREET, SUITE 201 Sacramento, CA 95816 916 369-3990



Peter D. Larimer

The Landscape Architects do not represent that these plans or the specifications in connection therewith are suitable, whether or not modified for any other site that the one for which they were specifically prepared. The Landscape Architects

C-5284

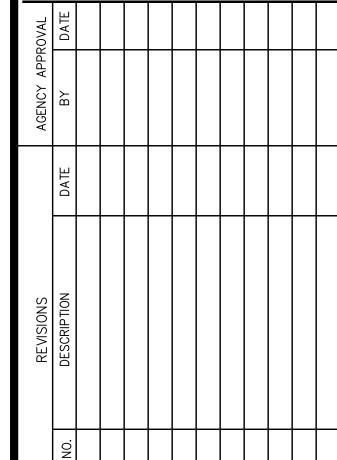

TER NEW PARKING LOT
CONNECTION
SEVALE RECREATION AND PARK DISTRICT

DATE

JOB NO. 22-018

06/18/24


SHEET TITLE

COVERSHEET

SHEET NO.


CVR

SHEET 1 OF 10

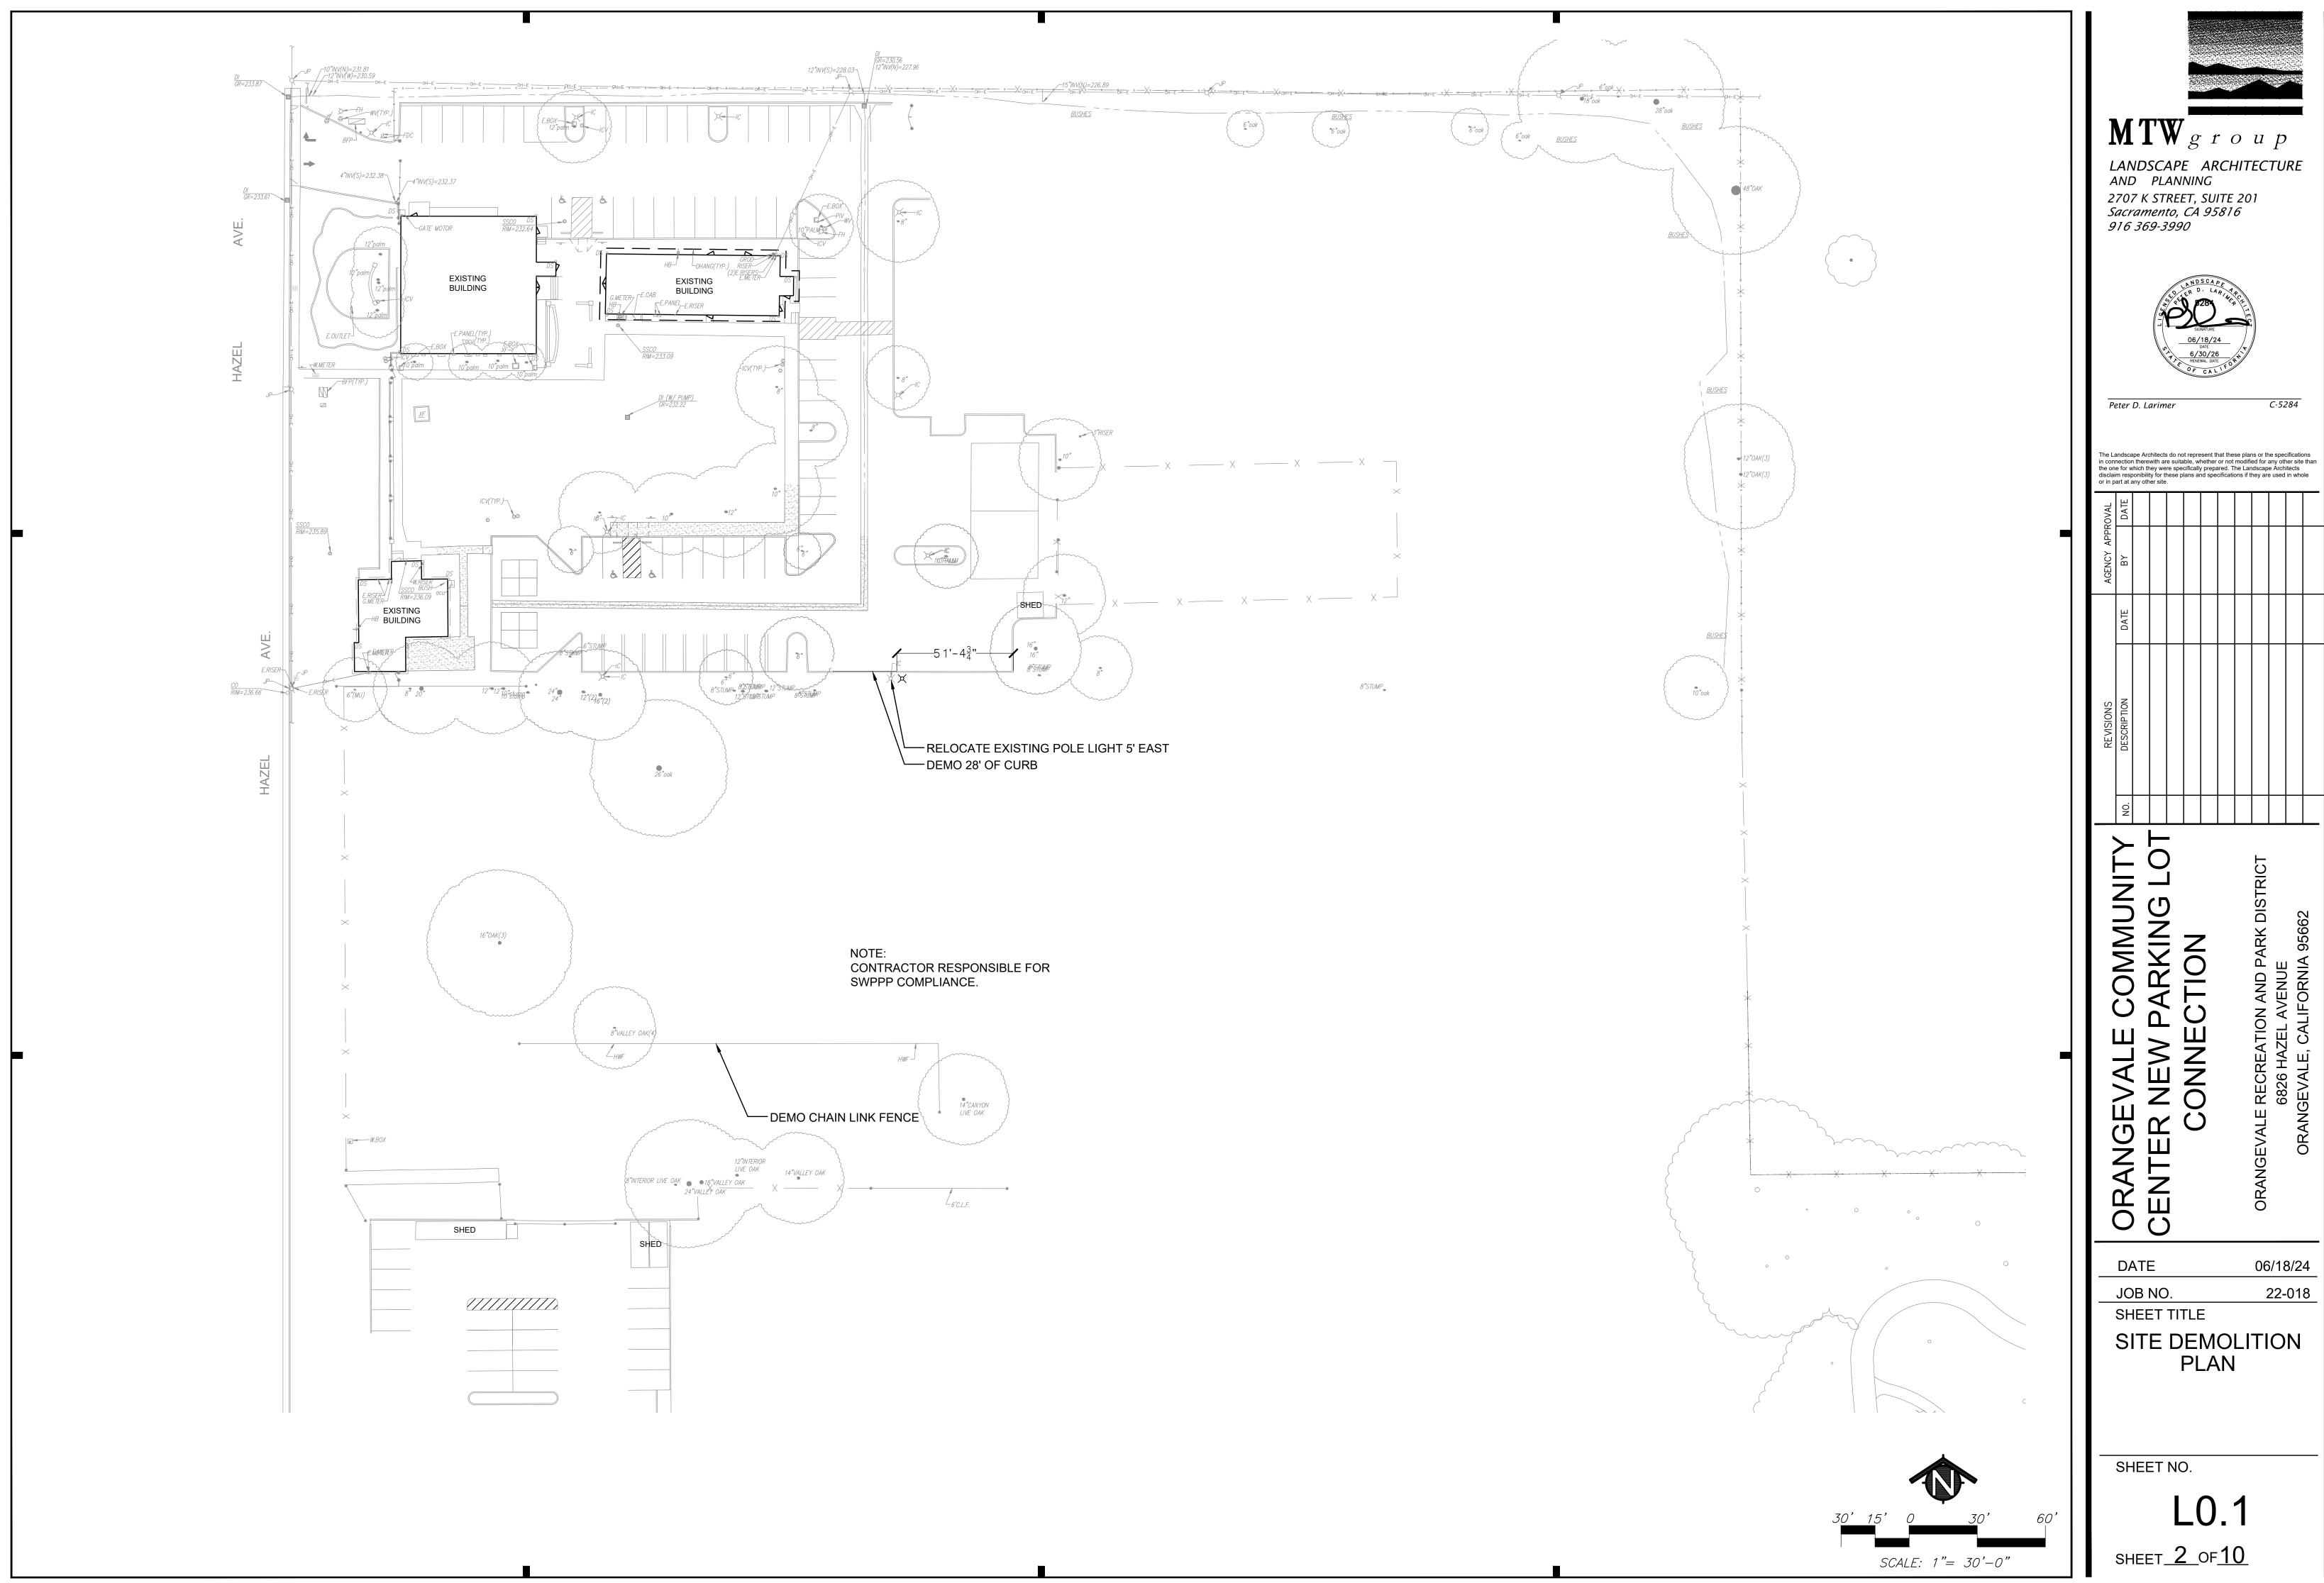


Š	REVISIONS DESCRIPTION	DATE	AGENCY APPROVAI BY DAT	SOVAI DAT


06/18/24

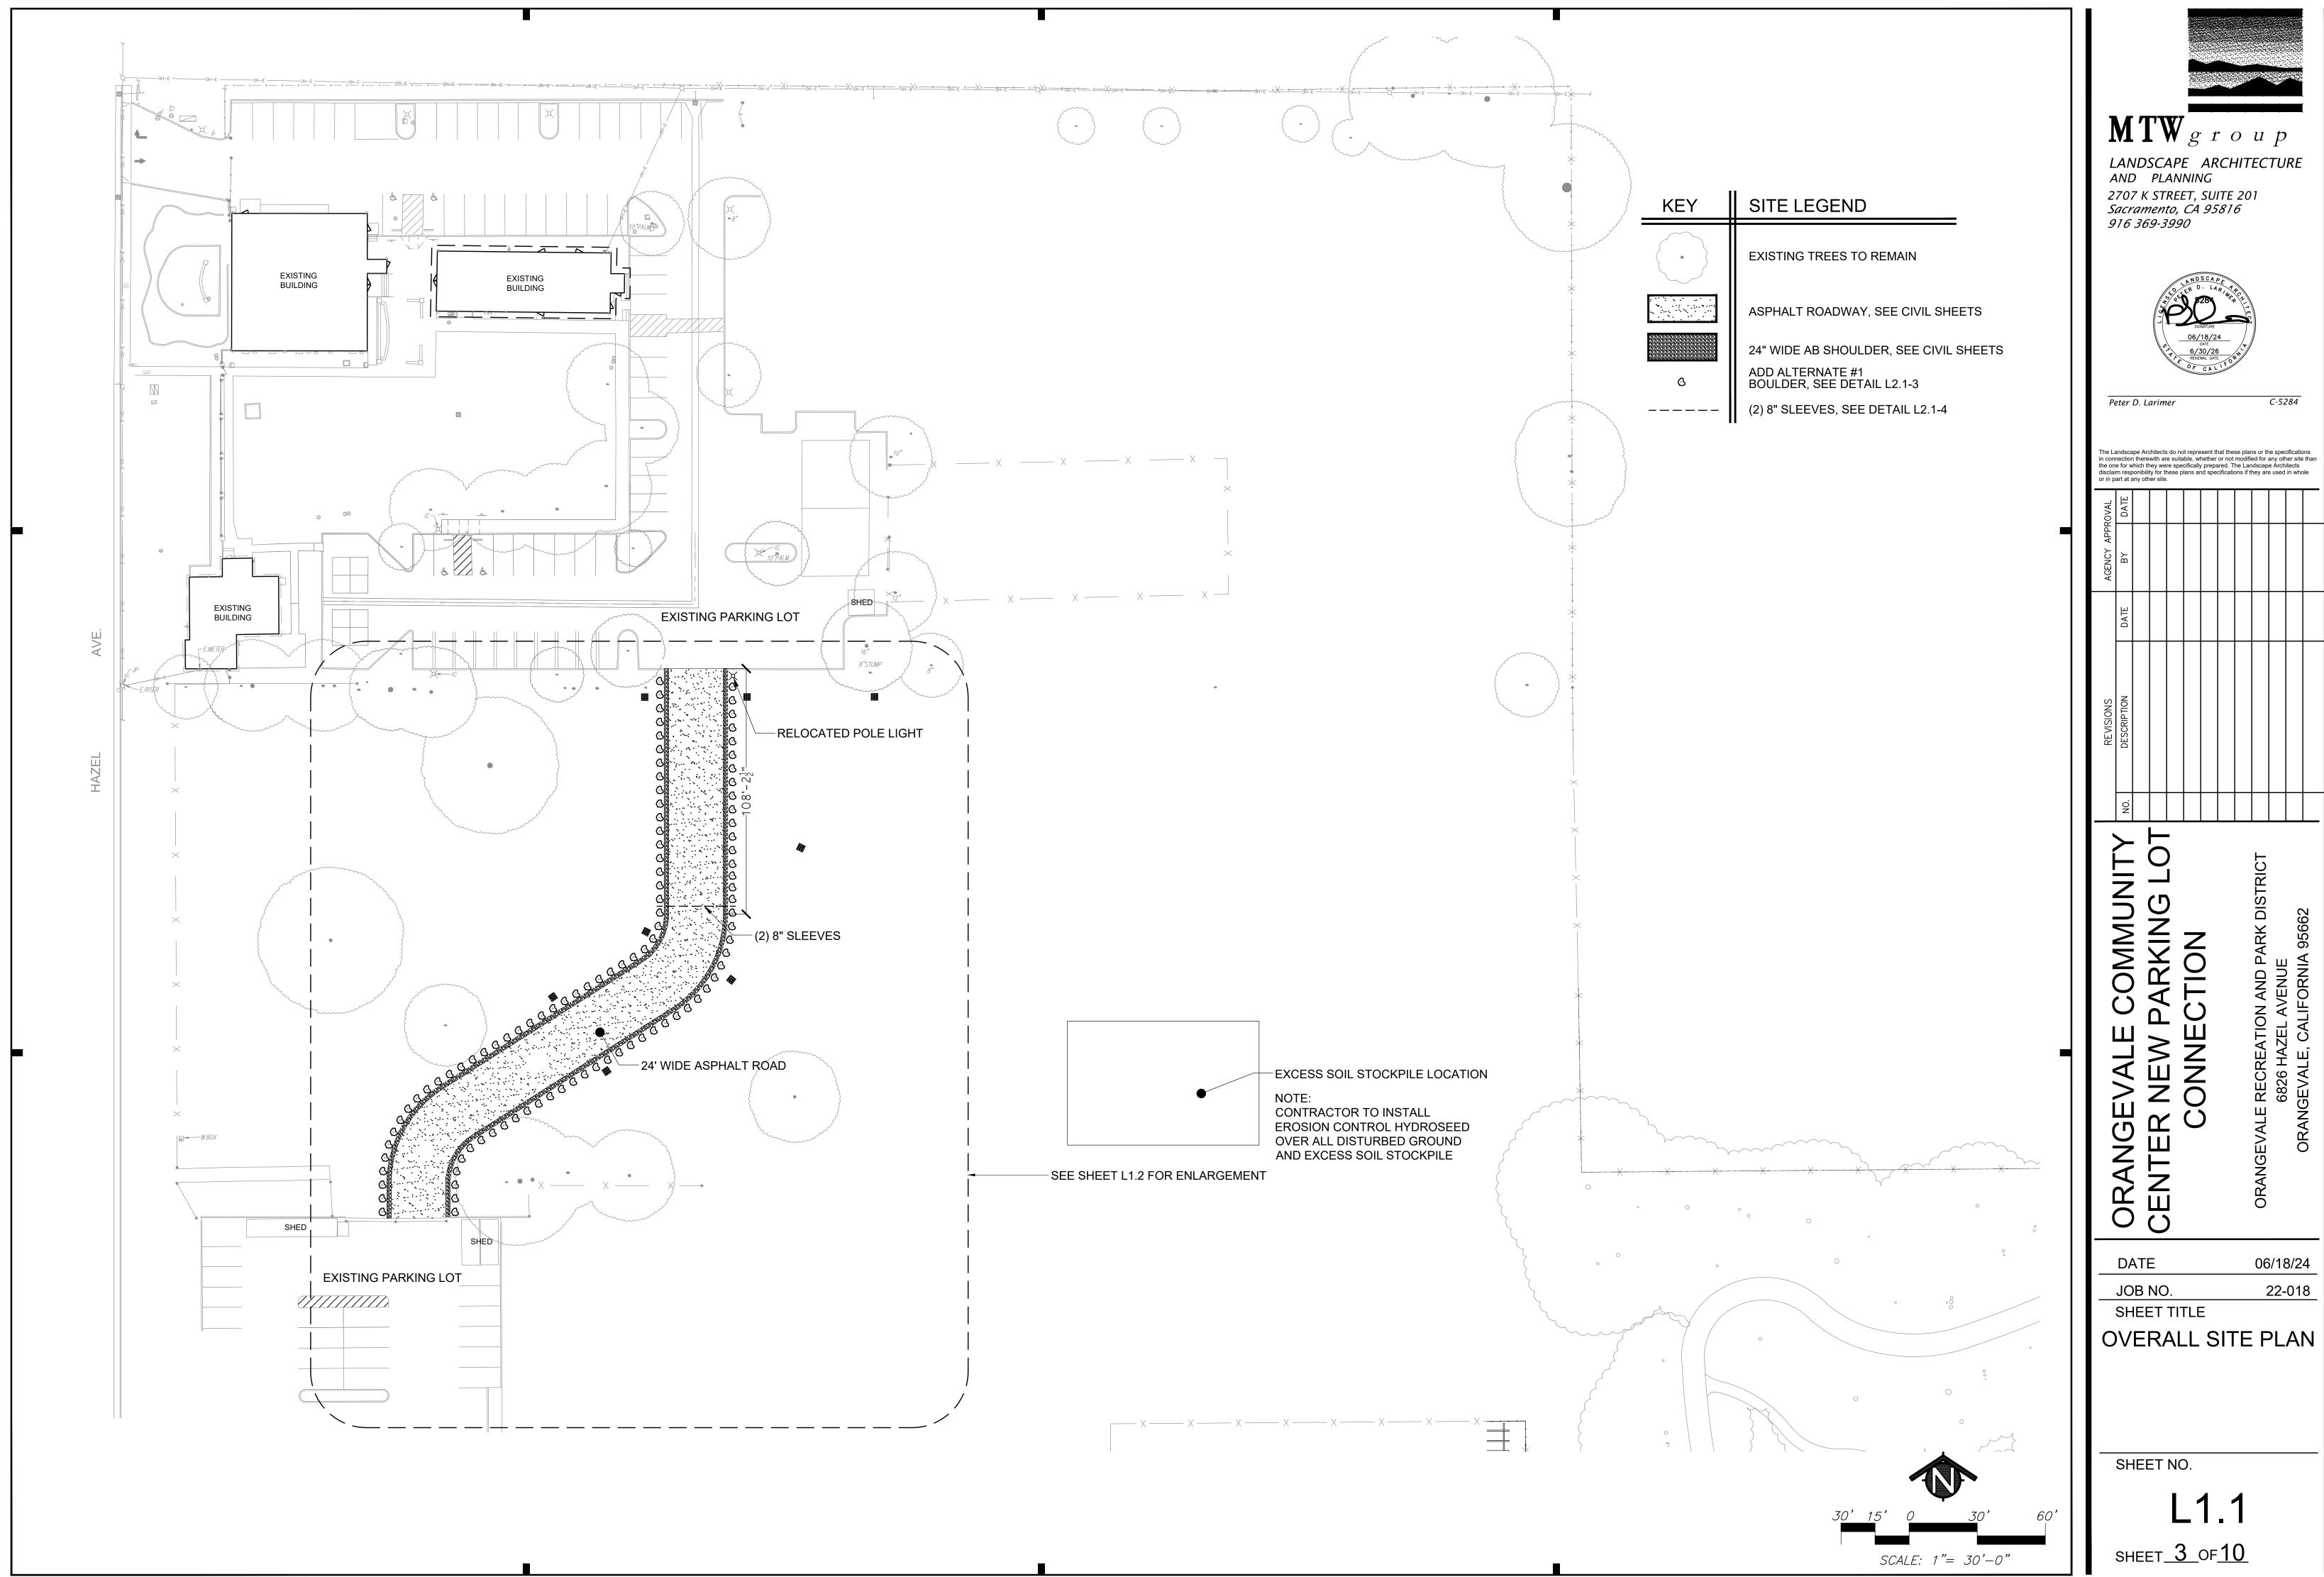

	REVISIONS		AGENCY APPRO	ೞ∣
NO.	DESCRIPTION	DATE	ВҮ	

06/18/24

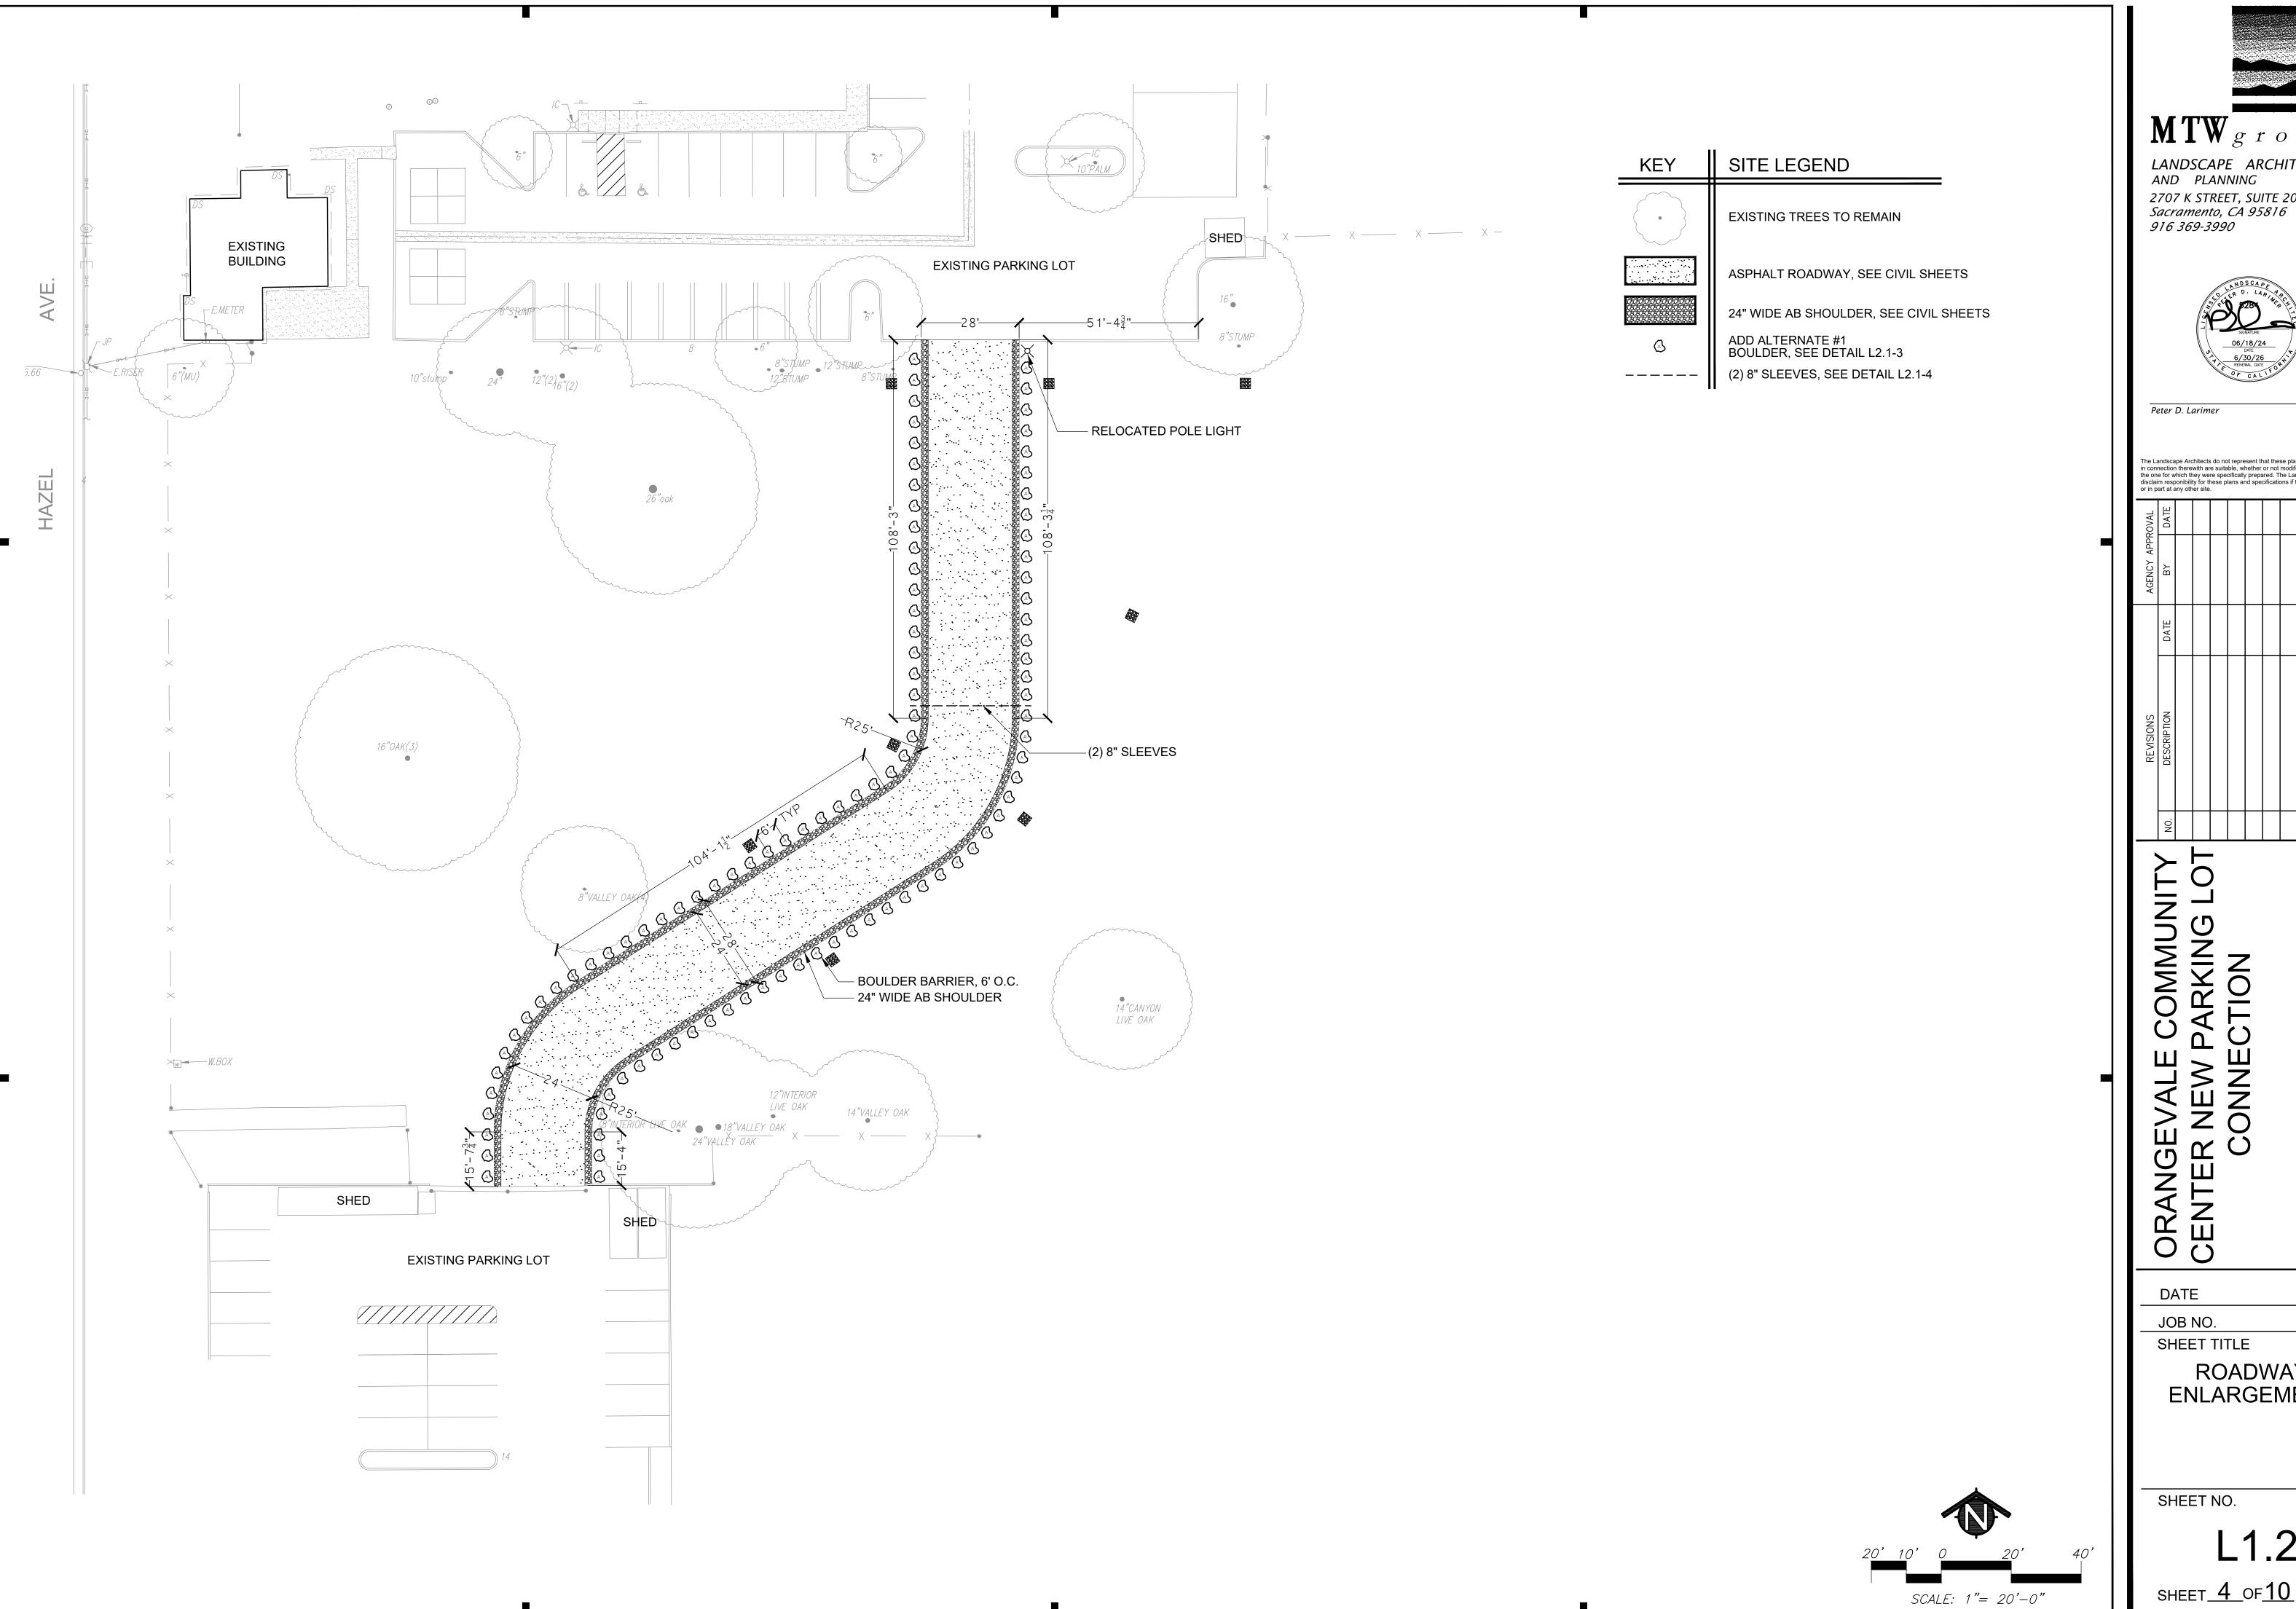

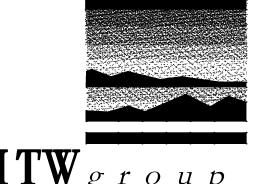

LANDSCAPE ARCHITECTURE AND PLANNING 2707 K STREET, SUITE 201



Peter D. Larimer

The Landscape Architects do not represent that these plans or the specifications in connection therewith are suitable, whether or not modified for any other site than the one for which they were specifically prepared. The Landscape Architects disclaim responibility for these plans and specifications if they are used in whole or in part at any other site.

C-5284

	NO.						
REVISIONS	DESCRIPTION						
	DATE						
AGENCY APF	ВҮ						


DATE 06/18/24 22-018 JOB NO.

SHEET TITLE

ROADWAY ENLARGEMENT

SHEET NO.

SHEET 4 OF 10

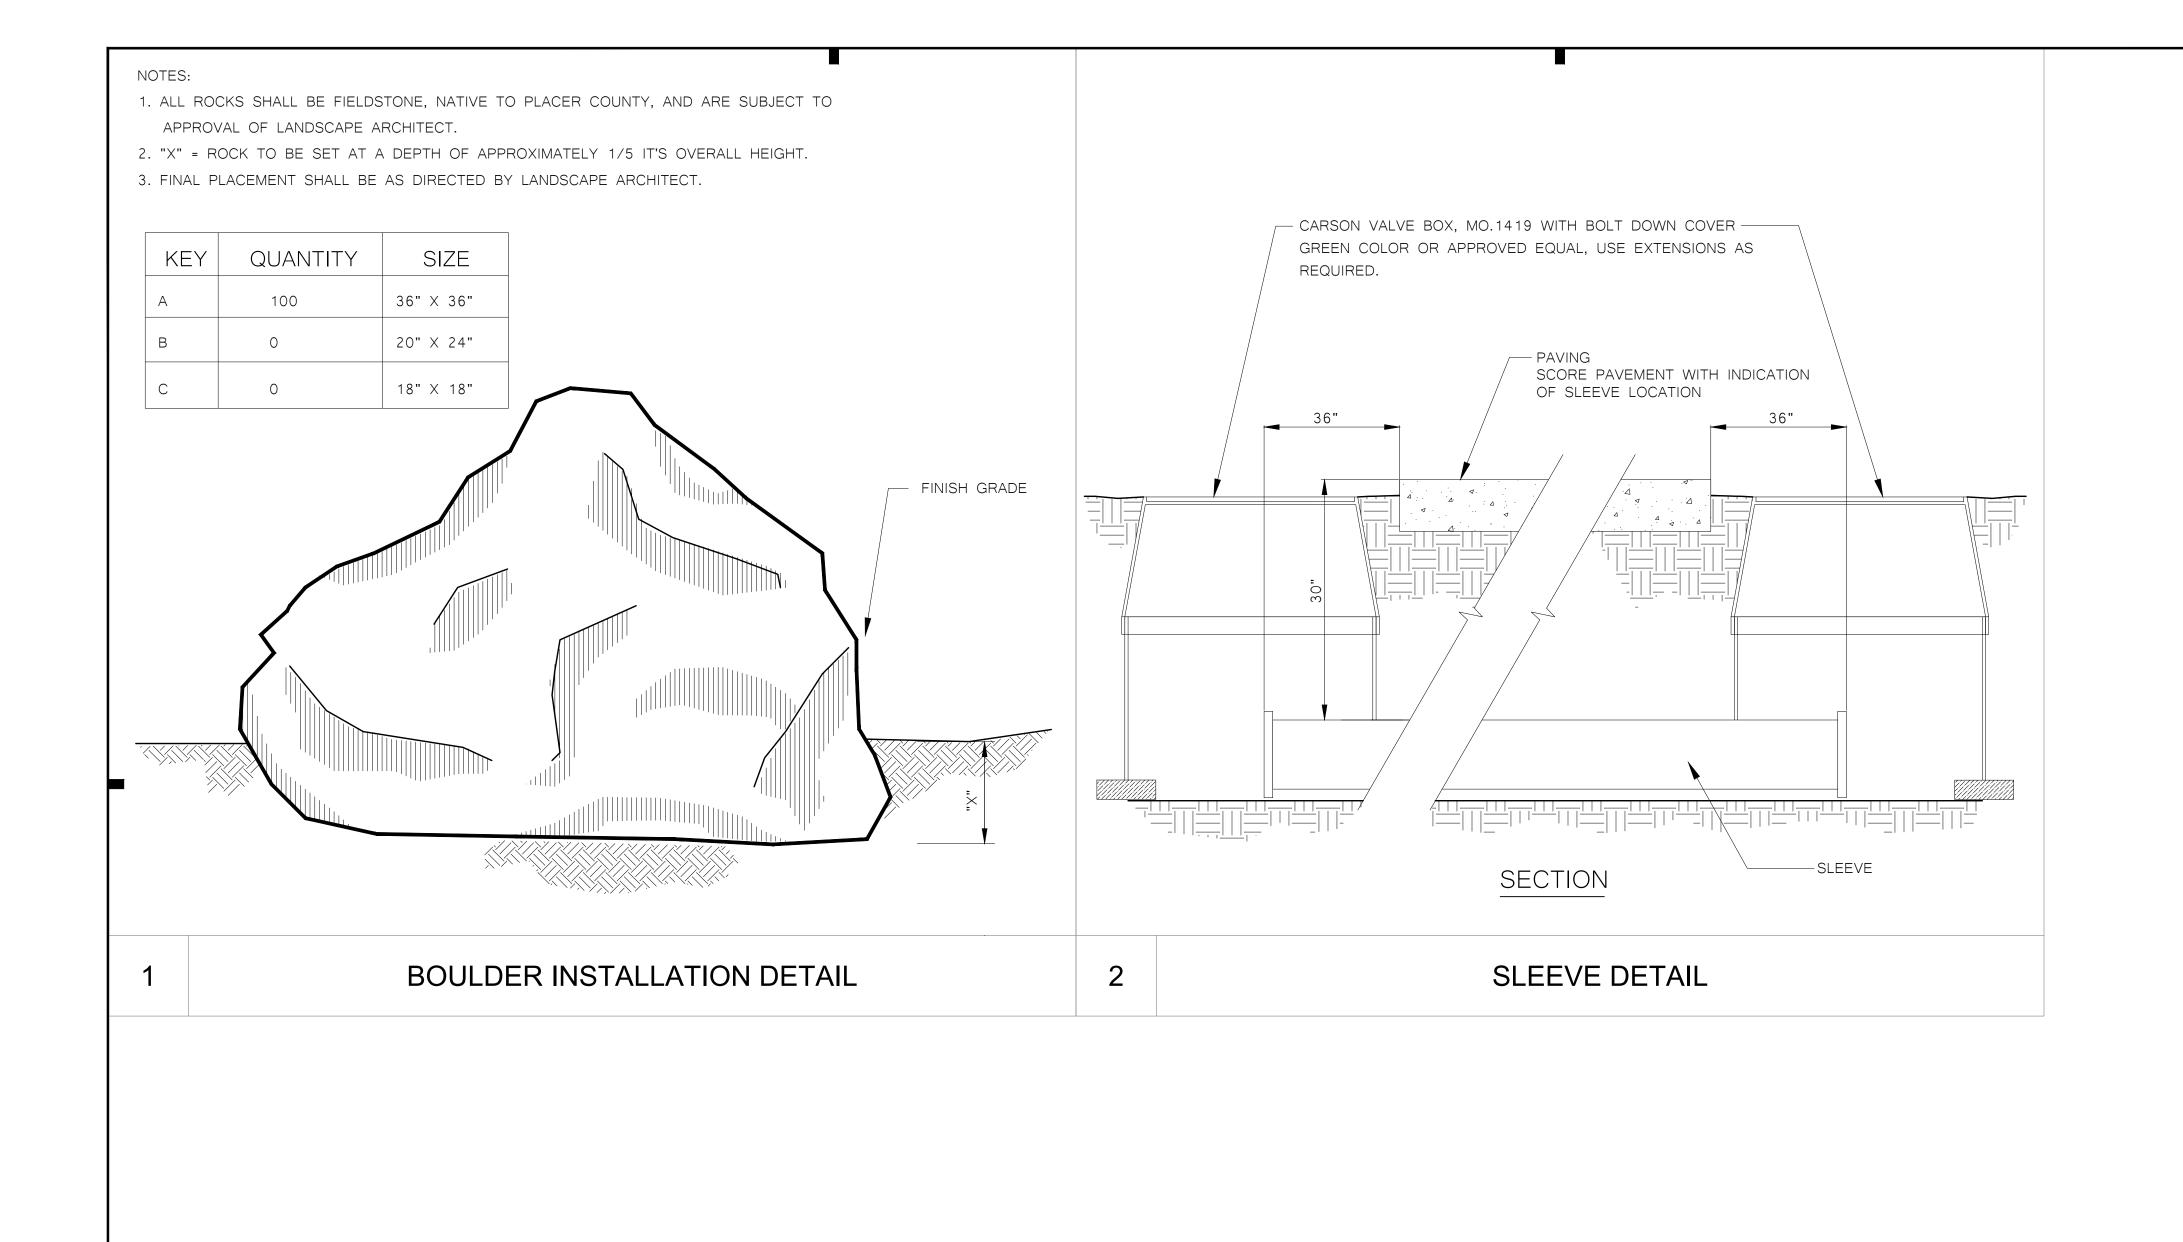



LANDSCAPE ARCHITECTURE
AND PLANNING

2707 K STREET, SUITE 201 Sacramento, CA 95816 916 369-3990



Peter D. Larimer

The Landscape Architects do not represent that these plans or the specifications in connection therewith are suitable, whether or not modified for any other site than the one for which they were specifically prepared. The Landscape Architects disclaim responibility for these plans and specifications if they are used in whole or in part at any other site.

C-5284

I	ROVAL	DATE						
	AGENCY APPROVAL	ЬЯ						
		DATE						
	REVISIONS	DESCRIPTION						
		NO.						

# ORANGEVALE COMMUNITY CENTER NEW PARKING LOT CONNECTION

DATE 06/18/24

JOB NO. 22-018

JOB NO. SHEET TITLE

CONSTRUCTION DETAILS

SHEET NO.

L2.1

SHEET <u>5</u> OF <u>10</u>

#### **ABBREVIATIONS** NOTE: NOT ALL ABBREVIATIONS BE USED ON THESE PLANS. AGGREGATE BASE ASPHALTIC CONCRETE AREA DRAIN APN ASSESSOR'S PARCEL NUMBER ARV AIR RELEASE VALVE AGGREGATE SUB-BASE BLOW-OFF VALVE BUTTERFLY VALVE BACK OF WALK CENTERLINE CATCH BASIN CONTROL JOINT CLASS CORRUGATED METAL PIPE CATV CABLE TELEVISION CO CLEANOUT COMMUNICATION CONC. CONCRETE CONST. CONSTRUCT CURB RETURN CONCRETE SURFACE DOUBLE CHECK VALVE DOUBLE DETECTOR CHECK VALVE DECOMPOSED GRANITE DROP INLET DIA DIAMETER DIP DUCTILE IRON PIPE DWG DRAWING DS DOWNSPOUT **ELECTRIC** EXPANSION JOINT EDGE OF PAVEMENT **ESMT** EASEMENT EXISTING FIRE SERVICE LINE FIRE DEPARTMENT CONNECTION FLOWLINE SANITARY SEWER FORCE MAIN FINISHED FLOOR ELEVATION FIRE HYDRANT GRADE BREAK GRATE ELEVATION GRADE ELEVATION GATE VALVE HOSE BIBB HEADER BOARD HDPE HIGH DENSITY POLYETHYLENE PIPE HIGH POINT PIPE INVERT ELEVATION JOINT UTILITY POLE LINEAL FEET LIP OF GUTTER LEFT MOWSTRIP NTS NOT TO SCALE OH OVERHEAD PAD BUILDING PAD PORTLAND CEMENT CONCRETE PCC PD PLANTER DRAIN PIV POST INDICATOR VALVE PROPERTY LINE POWER POLE PUBLIC UTILITY EASEMENT PVC POLYVINYL CHLORIDE REINFORCED CONCRETE PIPE RADIUS MANHOLE RIM ELEVATION (SOLID COVER) REDUCED PRESSURE BACKFLOW PREVENTER RIGHT OF WAY SCH SCHEDULE SD STORM DRAIN STORM DRAIN MANHOLE SDMH SUBGRADE ELEVATION FIRE SPRINKLER SERVICE SANITARY SEWER SSMH SANITARY SEWER MANHOLE STD STANDARD S/W SIDEWALK **TELEPHONE** TOP OF CURB TRENCH DRAIN TRENCH DRAIN CATCH BASIN TDCB TELEPHONE POLE TRW TOP OF RETAINING WALL TSW TOP OF SEAT WALL TOP OF WALK ELEVATION UTILITY UNDERGROUND UON UNLESS OTHERWISE NOTED VCP VITRIFIED CLAY PIPE WATER WITH

# SACRAMENTO METRO FIRE FIRE PREVENTION **APPROVAL**

MTHOUT

WATER VALVE

The Bureau does not assume any responsibility for designs. Permittee is responsible for errors in the plans found during Field Inspection. All work shall comply with the latest edition of the CFC, CBC, CPC, CMC, NFPA, and NEC as adopted and amended by the State of California in Title 24 CCR and Sacramento County Ordinance. These plans are NOT reviewed for ADA compliance.

R.K. 243447 07/12/2023

Approved for road connecting parking lots at Orangevale community center buildings.

### **LEGEND**

NOTE: NOT ALL SYMBOLS MAY BE USED ON THESE PLANS.

## PROPOSED GRADING & DRAINAGE SYMBOLS:

8" SD STORM DRAIN LINE (SIZE AND FLOW SHOWN) STORM DRAIN MANHOLE (SDMH) CATCH BASIN (CB) DROP INLET (DI) AREA DRAIN (AD) PLANTER DRAIN (PD) OR

> FLOOR DRAIN (FD) STORM DRAIN CLEANOUT ELEVATION

FINISHED FLOOR ELEVATION FF=100.00 PAD=99.33 BUILDING PAD ELEVATION CONCRETE SIDEWALK


GRADED DIRECTION FOR DRAINAGE FLOW SWALE


TREE TO BE REMOVED

# IMPROVEMENT PLANS

# ORANGEVALE COMMUNITY CENTER NEW PARKING LOT CONNECTION

6826 HAZEL AVE. ORANGEVALE, CA 95662

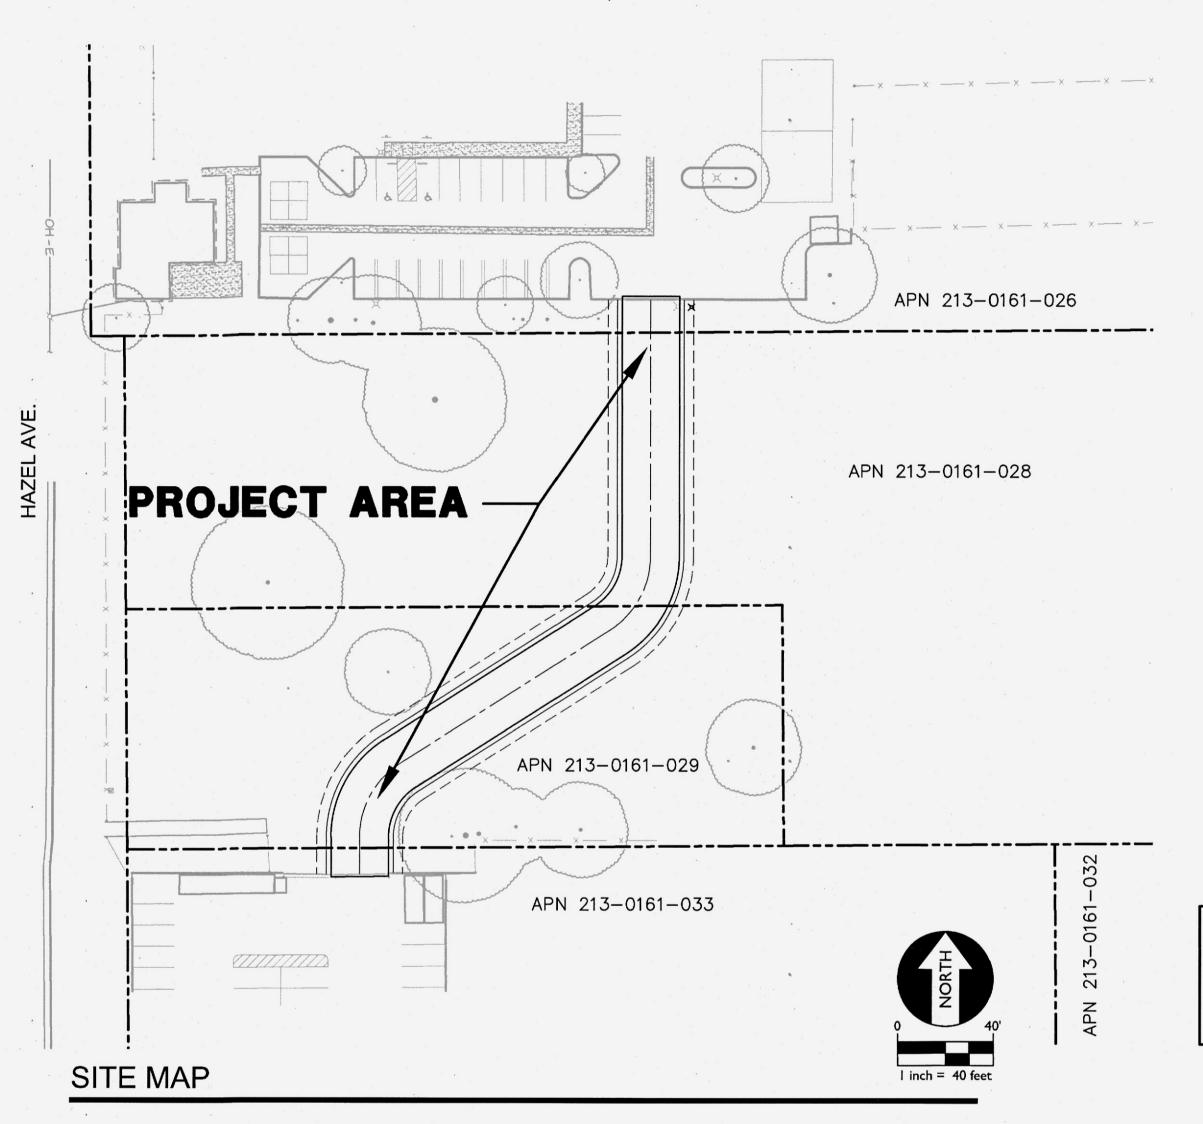

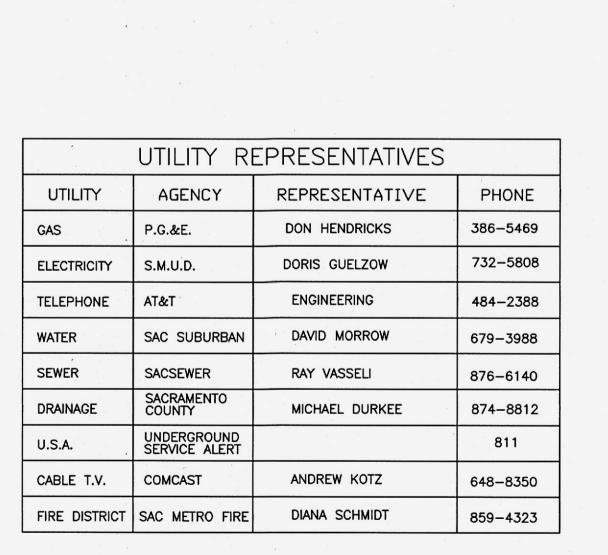


ORANGEVALE RECREATION AND PARK DISTRICT. 6826 HAZEL AVE. ORANGEVALE, CA 95662 916-988-4363

CIVIL ENGINEER: WARREN CONSULTING ENGINEERS, INC. 1117 WNDFIELD WAY, SUITE 110 EL DORADO HILLS, CA 95762 916-985-18-70

LANDSCAPE ARCHITECT: MTW GROUP 2707 K STREET, SUITE 201 SACRAMENTO, CA 95811 916-369-3990

· · · · · · · · · · · · · · · · · · ·		
WDID:	N/A	(5)
ONSTRUCTION START DATE:	JUNE	2024
NAL STABILIZATION DATE:	AUG.	2024
rea of disturbance (ac):	0.95	
OL OF CUT (CY): 1900	主 VOL. OF FILL:	100±
OST CONST. STORMWATER BMF	p's req? (Y/N):	NO

APPROVED BY: COUNTY ENGINEER

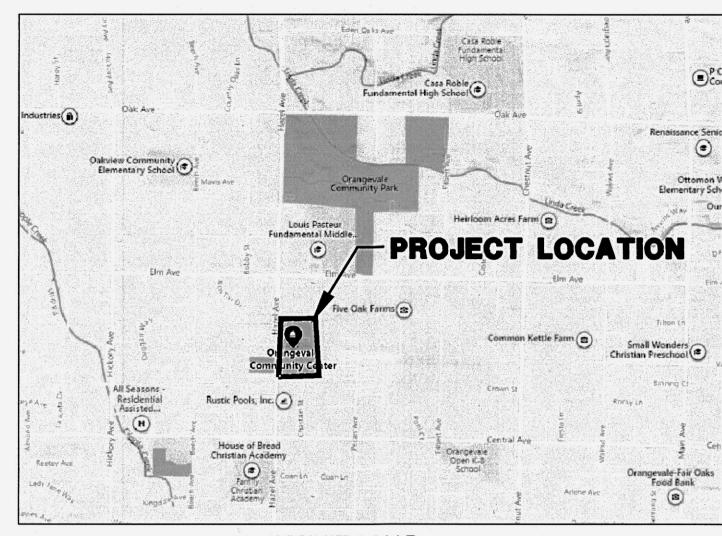

#### CIVIL PLANS

ORANGE VALE WATER COMPANY


COVER SHEET STANDARD NOTES TOPOGRAPHIC SURVEY GRADING PLAN EROSION CONTROL PLAN

BENCHMARK NO. <u>10-3</u> ELEV. <u>233.49</u> FND 76" METAL DISC STAMPED "CO. B.M. 10-3" LOCATED IN TOP OF CURB AT WEST END OF CURB RETURN AT NORTHWEST CORNER OF HAZEL AVE. AND LEVE AVE. NAVD88 = 236.11 NGVD29 = 233.49



EXPIRES ONE YEAR FROM DATE OF SIGNATURE SACRAMENTO METRO FIRE DISTRICT WATER DISTRICT: EXPIRES ONE YEAR FROM DATE OF SIGNATURE 10/4/23

RDER NUMBER: 90015082	DRAINAGE FEE:
PPROVED BY:	DATE:
PPROVED	
CALIFORNIA COORDINATES	N374000 E2223000
213-0161-026,	-028, -029, -032, -033
017 0161 006	008 000 070 077
SSESSORS PARCEL NUMBER(S)	
6826 HAZEL AVENU	E PARKING LOT CONNECTION
ROJECT TITLE	
MUNICIPAL SE	ERVICES AGENCY
	NTO COUNTY
<del></del>	

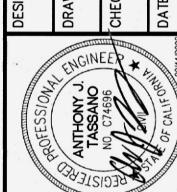



ORANGEVALE COMMUNITY CENTER NEW PARKING LOT CONNECTION ORANGEVALE RECREATION AND PARK DISTRICT 6826 HAZEL AVENUE

ET NO. C<sub>0.1</sub>

FILENAME: I: \22-060\CIVIL\DWG\22-060 C0.1.DWG

#### TREE PRESERVATION NOTES

- A. ALL NATIVE OAK TREES 6 INCHES DBH OR LARGER ON THE PROJECT SITE EXCEPT THOSE SPECIFICALLY APPROVED FOR REMOVAL, ALL PORTIONS OF ADJACENT OFF—SITE OAK TREES WHICH HAVE DRIPLINES THAT EXTEND OVER THE PROJECT SITE, AND ALL OFF—SITE OAK TREES WHICH MAY BE IMPACTED BY UTILITY INSTALLATION AND/OR IMPROVEMENTS ASSOCIATED WITH THIS PROJECT, SHALL BE PRESERVED AND PROTECTED AS FOLLOWS:
- 1. A CIRCLE WITH A RADIUS MEASUREMENT FROM THE TRUNK OF THE TREE TO THE TIP OF ITS LONGEST LIMB SHALL CONSTITUTE THE DRIPLINE PROTECTION AREA OF EACH TREE. LIMBS MUST NOT BE CUT BACK IN ORDER TO CHANGE THE DRIPLINE. THE AREA BENEATH THE DRIPINE IS A CRITICAL PORTION OF THE ROOT ZONE AND DEFINES THE MINIMUM PROTECTED AREA OF EACH TREE. REMOVING LIMBS WHICH MAKE UP THE DRIPLINE DOES NOT CHANGE THE PROTECTED AREA.
- 2. TEMPORARY PROTECTIVE FENCING SHALL BE INSTALLED AT LEAST ONE FOOT OUTSIDE THE DRIPLINES OF THE OAK TREES PRIOR TO INITIATING CONSTRUCTION IN ORDER TO AVOID DAMAGE TO THE TREE CANOPIES AND ROOT SYSTEMS.
- 3. ANY OAK TREES ON THE SITE THAT REQUIRE PRUNING SHALL BE PRUNED BY A CERTIFIED ARBORIST PRIOR TO THE START OF CONSTRUCTION WORK. ALL PRUNING SHALL BE IN ACCORDANCE WITH AMERICAN NATIONAL STANDARDS INSTITUTE (ANSI) A300 PRUNING STANDARDS AND THE INTERNATIONAL SOCIETY OF ARBORICULTURE (ISA) "TREE PRUNING GUIDELINES."
- 4. NO VEHICLES, CONSTRUCTION EQUIPMENT, MOBILE HOME/OFFICE, SUPPLIES, MATERIALS OR FACILITIES SHALL BE DRIVEN, PARKED, STOCKPILED OR LOCATED WITHIN THE DRIPLINES OF OAK TREES.
- 5. NO SIGNS, ROPES, CABLES (EXCEPT THOSE WHICH MAY BE INSTALLED BY A CERTIFIED ARBORIST TO PROVIDE LIMB SUPPORT) OR ANY OTHER ITEMS SHALL BE ATTACHED TO THE OAK TREES. SMALL METALLIC NUMBERING TAGS FOR THE PURPOSE OF PREPARING TREE REPORTS AND INVENTORIES SHALL BE ALLOWED.
- 6. NO GRADING (GRADE CUTS OR FILLS) SHALL BE ALLOWED WITHIN THE DRIPLINES OF THE OAK TREES. IF IT IS ABSOLUTELY NECESSARY TO EXCAVATE WITHIN THE DRIPLINE OF AN OAK, THE EXCAVATION SHALL BE DONE UNDER THE SUPERVISION OF A CERTIFIED ARBORIST.
- 7. DRAINAGE PATTERNS ON THE SITE SHALL NOT BE MODIFIED SO THAT WATER COLLECTS OR STANDS WITHIN, OR IS DIVERTED ACROSS, THE DRIPLINE OF ANY OAK TREE.
- 8. NO TRENCHING SHALL BE ALLOWED WITHIN THE DRIPLINES OF OAK TREES. IF IT IS ABSOLUTELY NECESSARY TO INSTALL UNDERGROUND UTILITIES WITHIN THE DRIPLINE OF AN OAK TREE, THE UTILITY LINE SHALL BE BORED AND JACKED UNDER THE SUPERVISION OF A CERTIFIED ABORIST.
- 9. THE CONSTRUCTION OF IMPERVIOUS SURFACES WITHIN THE DRIPLINES OF OAK TREES SHALL BE STRINGENTLY MINIMIZED.
- 10. NO SPRINKLER OR IRRIGATION SYSTEM SHALL BE INSTALLED IN SUCH A MANNER THAT SPRAYS WATER OR REQUIRES TRENCHING WITHIN THE DRIPLINES OF OAK TREES. AN ABOVE GROUND DRIP IRRIGATION SYSTEM IS RECOMMENDED.
- 11. LANDSCAPING BENEATH OAK TREES MAY INCLUDE NON-PLANT MATERIALS SUCH AS BARK MULCH, WOOD CHIPS, BOULDERS, ETC. THE ONLY PLANT SPECIES WHICH SHALL BE PLANTED WITHIN THE DRIPLINES OF OAK TREES ARE THOSE WHICH ARE TOLERANT OF THE NATURAL SEMI-ARID ENVIRONS OF THE TREES. LIMITED DRIP IRRIGATION APPROXIMATELY TWICE PER SUMMER IS RECOMMENDED FOR THE UNDERSTORY PLANTS.

#### SACRAMENTO COUNTY REQUIRED NOTES

- 1. ALL CONSTRUCTION AND MATERIALS SHALL BE IN ACCORDANCE WITH THE COUNTY OF SACRAMENTO STANDARD CONSTRUCTION SPECIFICATIONS AND IMPROVEMENT STANDARDS. WHERE INCONSISTENCIES EXIST, THE LATEST EDITION SHALL TAKE PRECEDENCE.
- 2. PUBLIC CONVENIENCE, PUBLIC SAFETY AND TRAFFIC CONTROL SHALL BE PROVIDED IN ACCORDANCE WITH SECTIONS 12-2 AND 12-3 OF THE STANDARD CONSTRUCTION SPECIFICATIONS AND AS DIRECTED BY THE COUNTY INSPECTOR. SAFE VEHICULAR AND PEDESTRIAN ACCESS SHALL BE PROVIDED AT ALL TIMES DURING CONSTRUCTION.
- 3. THE CONSULTANT ENGINEER SHALL NOTIFY THE COUNTY OF SACRAMENTO CONSTRUCTION OFFICE [PHONE: (916) 875-2700] UPON COMPLETION OF STAKING.
- 4. THE CONTRACTOR SHALL NOTIFY THE COUNTY OF SACRAMENTO CONSTRUCTION INSPECTION OFFICE TWO (2) WORKING DAYS PRIOR TO THE INTENTION TO COMMENCE WORK. THE CONTRACTOR SHALL NOT START ANY GRADING UNTIL THE COUNTY COMPLETES A PRE-CONSTRUCTION MEETING [(916) 875-2700].
- 5. THE COUNTY OF SACRAMENTO IS A MEMBER OF THE UNDERGROUND SERVICE ALERT (USA) ONE CALL PROGRAM. THE CONTRACTOR OR ANY SUBCONTRACTOR FOR THIS CONTRACT SHALL NOTIFY MEMBERS OF USA TWO (2) WORKING DAYS IN ADVANCE OF PERFORMING ANY EXCAVATION WORK BY CALLING THE TOLL—FREE NUMBER: 1(800) 227—2600. THOMAS BROTHERS MAP PAGE 259 INDEX D6.
- 6. THE CONTRACTOR SHALL BE RESPONSIBLE FOR THE PROTECTION OF ALL EXISTING SURVEY MONUMENTS OR MARKERS. MONUMENTS OR MARKERS DESTROYED DURING CONSTRUCTION SHALL BE REPLACED AT THE CONTRACTOR'S EXPENSE.
- 7. ALL SERVICE SEWERS SHALL HAVE FOUR (4) TO FIVE (5) FEET OF COVER AT THE PROPERTY LINE OR RIGHT-OF-WAY. UNLESS OTHERWISE NOTED ON PLANS.
- 8. EROSION CONTROL MEASURES SHALL BE IN ACCORDANCE WITH SECTION 11 OF THE COUNTY OF SACRAMENTO IMPROVEMENT STANDARDS.
- 9. THE CONTRACTOR SHALL NOTIFY THE COUNTY INSPECTOR IF EXCESS SOIL IS DISPOSED OFF SITE. THE DISPOSAL OF EXCESS SOIL SHALL NOT COMMENCE UNTIL THE COUNTY INSPECTOR HAS VERIFIED THAT THE EXPORT SITE IS NOT SUBJECT TO THE COUNTY GRADING ORDINANCE NOR THE FLOODPLAIN ORDINANCE.
- 10. ALL TRENCH RESTORATION SHALL COMPLY WITH SECTION 14 "RESTORATION OF SURFACES" OF THE SACRAMENTO COUNTY STANDARD CONSTRUCTION SPECIFICATIONS.
- 11. EROSION AND SEDIMENT CONTROL MEASURES FOR THIS PROJECT SHALL BE IN SUBSTANTIAL COMPLIANCE WITH THE STORM WATER POLLUTION PREVENTION PLAN (SWPPP) PREPARED FOR THE PROJECT IN ACCORDANCE WITH THE STATE'S GENERAL PERMIT FOR CONSTRUCTION ACTIVITIES. ACCORDING TO STATE LAW, IT IS THE RESPONSIBILITY OF THE PROPERTY OWNER TO MAINTAIN SWPPP UP—TO—DATE TO REFLECT CHANGING CONDITIONS AND ENSURE MOST CURRENT SWPPP IS AVAILABLE ON THE PROJECT SITE AT ALL TIMES FOR REVIEW BY COUNTY AND STATE INSPECTORS. (FOR PROJECTS WITH PRIVATE ROADS WITHIN SAC—METRO FIRE DISTRICT)
- 12. THE DEVELOPER SHALL CONTACT THE SAC-METRO FIRE DISTRICT AT (916) 859-4330 FOR INSPECTION AND ACCEPTANCE OF THE PRIVATE ROAD PRIOR TO COUNTY PROJECT ACCEPTANCE

#### DRAINAGE NOTES

- 1. ALL CONSTRUCTION AND MATERIALS FOR DRAINAGE SHALL BE IN ACCORDANCE WITH THE LATEST EDITION OF THE COUNTY OF SACRAMENTO IMPROVEMENT STANDARDS AND STANDARD CONSTRUCTION SPECIFICATIONS. WHERE DISCREPANCIES EXIST, APPROPRIATE NOTES SHALL BE ADDED TO THE PLANS, TAKING PRECEDENCE OVER THE STANDARD CONSTRUCTION SPECIFICATIONS.
- 2. THE MINIMUM COVER REQUIREMENTS DURING CONSTRUCTION FOR TEMPORARY CONSTRUCTION VEHICLE LOADING SHALL BE 4 FEET FOR METAL AND PLASTIC PIPE, AND 3 FEET FOR REINFORCED CONCRETE PIPE.
- 3. THE CONTRACTOR SHALL PLACE THE PROPER STRENGTH PIPE IF TRENCH CONDITIONS ENCOUNTERED DIFFER FROM THE DESIGN TRENCH.
- 4. DRAINAGE IN PUBLIC ROW AND DRAINAGE EASEMENTS SHALL CONFORM TO THE FOLLOWING:
  - A. DRAINAGE PIPE MATERIAL PIPE SHALL CONFORM TO SECTION 36 AND SECTION 50 (EXCLUDING 50-20, WHICH IS NOT ALLOWED) OF THE STANDARD CONSTRUCTION SPECIFICATIONS.
  - B. DRAINAGE MANHOLES SHALL CONFORM TO SECTION 39 OF THE STANDARD CONSTRUCTION SPECIFICATIONS.
- 5. TESTING OF DRAINAGE SYSTEMS
  - A. DRAINAGE IN PUBLIC ROW AND DRAINAGE EASEMENTS SHALL CONFORM TO THE FOLLOWING:

    i. DRAINAGE PIPES, INCLUDING DRAIN INLET LATERALS, SHALL BE TESTED IN CONFORMANCE WITH SECTION 38-10 OF THE STANDARD CONSTRUCTION SPECIFICATIONS.
  - ii. STORM DRAIN MANHOLES SHALL BE TESTED IN CONFORMANCE WITH SECTION 39-4.02 OF THE STANDARD CONSCTRUCTION SPECIFICATIONS.
- 6. RESILIENT CONNECTORS, IN CONFORMANCE WITH SECTION 39-2.02 AND STD. DWG. 9-7A OF THE STANDARD CONSTRUCTION SPECIFICATIONS, ARE REQUIRED BETWEEN PRE-CAST MANHOLE AND PIPE, AND BETWEEN PRE-CAST DROP INLET AND PIPE. WATER STOPS ARE REQUIRED FOR PIPE TO CAST-IN-PLACE MANHOLE/DROP INLET CONNECTIONS.
- 7. EROSION CONTROL STRUCTURES (STD. DWG. 9-27) SHALL BE CLASS B CONCRETE, NOT GROUTED COBBLE.
- 8. ALL DRAINAGE INLETS IN PUBLIC ROW, PRIVATE PROPERTY, AND DRAINAGE EASEMENTS SHALL HAVE A PERMANENT STORM DRAIN MESSAGE "NO DUMPING FLOWS TO CREEK" OR OTHER APPROVED MESSAGE CONSISTENT WITH SECTION 9—14G AND STD. DWGS 11—10A AND 11—10B OF THE SACRAMENTO COUNTY IMPROVEMENT STANDARDS.

#### WCE GENERAL NOTES

1. THE TYPES, LOCATIONS, SIZES, AND/OR DEPTHS OF EXISTING UNDERGROUND UTILITIES AS SHOWN ON THESE PLANS WERE OBTAINED FROM SOURCES OF VARYING RELIABILITY. THE CONTRACTOR IS CAUTIONED THAT ONLY ACTUAL EXCAVATION WILL REVEAL THE TYPES, EXTENT, SIZES, LOCATIONS AND DEPTHS OF SUCH UNDERGROUND UTILITIES. A REASONABLE EFFORT HAS BEEN MADE TO LOCATE AND DELINEATE ALL KNOWN UNDERGROUND UTILITIES. HOWEVER, WARREN CONSULTING ENGINEERS CAN ASSUME NO RESPONSIBILITY FOR THE COMPLETENESS OR ACCURACY OF ITS DELINEATION OF SUCH UNDERGROUND UTILITIES, NOR FOR THE EXISTENCE OF OTHER BURIED OBJECTS OR UTILITIES WHICH MAY BE ENCOUNTERED BUT WHICH ARE NOT SHOWN ON THESE PLANS. THE CONTRACTOR OR ANY SUBCONTRACTOR FOR THIS CONTRACT SHALL NOTIFY MEMBERS OF UNDERGROUND SERVICE ALERT (USA) TWO (2) WORKING DAYS IN ADVANCE OF PERFORMING ANY EXCAVATION WORK BY CALLING TOLL FREE 1-800-227-2600, OR 811.



- 2. WARREN CONSULTING ENGINEERS, INC. (WCE) ASSUMES NO RESPONSIBILITY FOR ERRORS IN PHYSICAL LOCATION OF IMPROVEMENTS, HORIZONTAL OR VERTICAL. IN ADDITION, ANY SUCH ERRORS IN PHYSICAL LOCATION MAY AFFECT THE INTENDED DESIGN OF SUCH IMPROVEMENTS AND WCE CANNOT BE HELD RESPONSIBLE FOR SUCH CONDITIONS WHICH ARE A RESULT OF ERRORS IN SURVEYING, OR IMPROPER CONSTRUCTION.
- 3. IF SUBSURFACE CULTURAL RESOURCES, REMAINS, AND/OR ARTIFACTS ARE UNCOVERED DURING PROJECT CONSTRUCTION, ALL WORK IN THE VICINITY SHALL BE STOPPED UNTIL SUCH ITEMS CAN BE ASSESSED BY AN APPROPRIATE MEMBER OF THE COUNTY ENVIRONMENTAL IMPACT SECTION STAFF.
- 4. CONTRACTOR AGREES THAT HE/SHE SHALL ASSUME SOLE AND COMPLETE RESPONSIBILITY FOR JOB SITE CONDITIONS DURING THE COURSE OF CONSTRUCTION OF THIS PROJECT, INCLUDING SAFETY OF ALL PERSONS AND PROPERTY: THAT THIS REQUIREMENT SHALL APPLY CONTINUOUSLY AND SHALL NOT BE LIMITED TO NORMAL WORKING HOURS: AND THAT THE CONTRACTOR SHALL DEFEND, INDEMNIFY AND HOLD THE OWNER AND ENGINEER HARMLESS FROM ANY AND ALL LIABILITY, REAL OR ALLEGED, IN CONNECTION WITH THE PERFORMANCE OF WORK ON THIS PROJECT, EXCEPTING FOR LIABILITY ARISING FROM THE SOLE NEGLIGENCE OF THE OWNER OR ENGINEER.
- 5. THE CONTRACTOR SHALL OBTAIN AN EXCAVATION PERMIT FROM THE STATE OF CALIFORNIA DEPARTMENT OF INDUSTRIAL SAFETY FOR ALL EXCAVATIONS OF 5 FEET OR MORE IN DEPTH.
- 6. IT SHALL BE THE CONTRACTOR'S RESPONSIBILITY TO MAKE NECESSARY PRE—CONSTRUCTION SITE REVIEWS TO DETERMINE NECESSARY MEANS AND METHODS TO COMPLETE THE IMPROVEMENTS SHOWN ON THESE PLANS.
- 7. WHERE IMPROVEMENTS LIE WITHIN AN EXISTING DEVELOPED AREA, CONTRACTOR SHALL USE CAUTION WHEN ACCESSING THE SITE THROUGH THESE EXISTING IMPROVEMENTS. IT IS THE CONTRACTORS RESPONSIBILITY TO PROTECT ANY SUCH EXISTING IMPROVEMENTS OUTSIDE THE PROJECT BOUNDARY, OR EXISTING IMPROVEMENTS WITHIN THE BOUNDARY WHICH ARE TO REMAIN. PROPER PRECAUTIONS SHALL BE PROVIDED AND MAINTAINED THROUGHOUT CONSTRUCTION. ANY DAMAGE SHALL BE REPAIRED OR REPLACED TO THE SATISFACTION OF THE OWNER.
- 8. IT IS THE RESPONSIBILITY OF THE CONTRACTOR TO KEEP DETAILED RECORDS OF MINOR CHANGES OR ADJUSTMENTS MADE DURING CONSTRUCTION (WHICH WERE NOT FORMALLY ISSUED). UPON PROJECT COMPLETION, THESE RECORDS AND/OR INFORMATION SHALL BE PROVIDED TO THE OWNER AND WARREN CONSULTING ENGINEERS, INC. UNLESS AN OFFICIAL "AS-BUILT" SET OF PLANS IS A REQUIREMENT OF THE CONTRACT. IF AS-BUILT PLANS ARE A REQUIREMENT OF THE CONTRACT, REFER TO SPECIFICATIONS FOR AS-BUILT DELIVERABLE REQUIREMENTS.
- 9. IN VEHICULAR PATHWAYS, EXISTING ASPHALTIC AND/OR CONCRETE SURFACES SHALL BE CUT TO A NEAT AND STRAIGHT LINE, PARALLEL OR PERPENDICULAR TO THE VEHICULAR TRAVELED PATH. THIS IS TYPICALLY THE ROADWAY CENTERLINE, BUT MAY VARY. THAT SAWCUT EDGE SHALL BE PROTECTED FROM DAMAGE DURING CONSTRUCTION SO A CLEAN EDGE REMAINS FOR PATCH BACK.. IF EDGE IS DAMAGED, A NEW SAW CUT WILL BE REQUIRED. THE EXPOSED EDGE SHALL BE "TACKED" WITH EMULSION PRIOR TO PAVING.
- 10. NO BURNING OR BLASTING SHALL BE ALLOWED ONSITE UNLESS SPECIFICALLY ADDRESSED ON PLANS, OR SPECIFICALLY APPROVED AND COORDINATED WITH THE ARCHITECT, ENGINEER, AND LOCAL AGENCY OR OTHER ADMINISTRATIVE AUTHORITY.
- 11. SUBGRADE AND RESULTING FINISHED GRADE SHALL BE CONSTRUCTED SMOOTH AND UNIFORM BETWEEN SPOT ELEVATIONS, CONTOURS OR OTHER STRUCTURE ELEVATIONS SHOWN ON GRADING OR OTHER PLANS. NO MOUNDS, RUTS, DEPRESSIONS OR OTHER GRADING DEFICIENCIES WILL BE ALLOWED UNLESS SPECIFICALLY SHOWN ON PLANS.
- 12. ON NEW WATER SYSTEMS, SERVICE LATERALS SHALL BE MADE USING APPROPRIATE "TEE" AND "WYE" FITTINGS. SADDLE TAPS WILL ONLY BE ALLOWED WHEN MAKING CONNECTIONS TO EXISTING WATER MAINS.
- 13. CURING COMPOUND SHALL BE APPLIED IN A CONTINUOUS SOLID WET FLOWING COAT. ANY "SPOTTY" APPLICATIONS SHALL BE RECOATED IMMEDIATELY. APPLICATION SHALL BE INSPECTED BY PROJECT INSPECTOR DURING APPLICATION.
- 14. EMBEDMENT OF FEATURES IN CONCRETE PAVING, CURBS, OR WALLS, SUCH AS SQUARE OR ROUND TUBING, POSTS, OR COLUMNS, STEEL BOLTED PLATES, OR OTHER STRUCTURES, SHALL REQUIRE ADDITIONAL SCORE OR EXPANSION JOINTS TO PREVENT UNCONTROLLED CRACKING. THOSE ADDITIONAL JOINTS MAY OR MAY NOT BE SPECIFICALLY SHOWN ON PLANS BUT SHALL BE PROVIDED BY THE CONTRACTOR.
- 15. EMBEDMENT OF FEATURES IN CONCRETE PAVING, CURBS, OR WALLS, SUCH AS SQUARE OR ROUND TUBING, POSTS, OR COLUMNS, STEEL BOLTED PLATES, OR OTHER STRUCTURES, SHALL REQUIRE A MINOR ADJUSTMENT OF REBAR WITHIN CONCRETE TO ALLOW FOR SUCH STRUCTURE. THAT REBAR ADJUSTMENT MAY NOT BE SPECIFICALLY SHOWN ON PLANS.
- 16. NO MORE THAN 1 GALLON OF WATER PER YARD OF CONCRETE CAN BE ADDED TO THE TRUCK AFTER ARRIVAL TO PROJECT SITE. THE ADDITION OF WATER CAN ONLY BE ADDED UNDER THE SUPERVISION OF THE CONCRETE INSPECTOR OR LABORATORY TECHNICIAN.
- 17. WHEN PUMPING CONCRETE FOR PLACEMENT, ABSOLUTELY NO WATER IS TO BE ADDED TO PUMP HOPPER. ANY WATER ADDED TO HOPPER WILL BE REASON FOR CONCRETE REJECTION AT THE CONTRACTORS EXPENSE.
- 18. ALL CONTRACTION/CONSTRUCTION JOINTS "CJ" SHALL BE 1/4 THE SLAB THICKNESS DEEP, BUT NO LESS THAN 1" FOR CONTROLLING OF CRACKING. CONTRACTOR SHALL EXERCISE CAUTION WHEN FINAL TROWELING OF CONCRETE SO AS NOT TO FILL IN THESE JOINTS WITH CONCRETE CREAM. ANY CRACKS OUTSIDE OF JOINTS WHICH WERE CONSTRUCTED LESS THAN 1" DEEP, SHALL BE CAUSE FOR CONCRETE SLAB(S) TO BE REMOVED AND REPLACE AT CONTRACTORS EXPENSE.
- 19. ANY SCREED BOARDS SET WITHIN CONCRETE SLABS SHALL BE AN "OVERHEAD SCREED" SO THERE IS NO INTERFERENCE WITH THE PLACEMENT AND ALIGNMENT OF SLAB REINFORCING.
- 20. 3-1/2" FELT JOINTS WILL NOT BE ACCEPTED. PROVIDE A FULL 4" FELT JOINT FOR 4" SLAB CONSTRUCTION, AND A 6" FELT JOINT FOR A 6" SLAB SLAB CONSTRUCTION.
- 21. SHOULD ANY SHRINKAGE CRACKS OCCUR OUTSIDE OF EITHER THE EXPANSION JOINTS OR CRACK CONTROL JOINTS, THEN THE CONCRETE SLAB SHALL BE SAWCUT AT THE NEAREST JOINTS ON EACH SIDE OF THE CRACK AND THE CONCRETE SECTION SHALL BE, REMOVED AND REPLACED. NEW CONCRETE SHALL BE DOWELED INTO EXISTING CONCRETE PER DRAWING DETAIL.
- 22. ALL AREAS DISTURBED BY GRADING OPERATIONS WHETHER SHOWN ON THE DRAWINGS OR NOT SHALL BE HYDROSEEDED UNLESS OTHERWISE NOTED. HYDRO SEEDING SHALL CONFORM TO LOCAL CITY/COUNTY STANDARDS.
- 23. REPAIR OR PATCHING OF GALVANIZED METALS, SUCH AS AFTER WELDING GALVANIZED COMPONENTS, SHALL BE MADE USING A ZINC COMPOSITION "HOT STICK" APPLICATION PER ASTM A 780-01. GALVANIZING PAINTS WILL NOT BE ALLOWED.

	213-0161-026, -028, -029, -032, -03	_ ELEV. <u>233.49</u>	STAMPED "CO. B.M. TOP OF CURB AT RETURN AT OF HAZEL AVE. AND
below. you dig.	161-026,	10–3	
DN .	.N. 213-0	HMARK NO.	7%" METAL DISC -3" LOCATED IN ' ST END OF CURB RTHWEST CORNER

DESIGNED: MG DRAWN:	ON N	REVISIONS DESCRIPTION	DATE	AGENCY APP	ROVAL	AGENCY APPROVAL HORIZONTAL  SCALE:  AS NOTED  ANEDTICAL SCALE:	A.P.N. BENCHMA	A.P.N. 213-0161-026, -02  BENCHMARK NO. 10-3  FND 78" METAL DISC STAI
CHECKED: MG  DATE:						VERTICAL SCALE: AS NOTED JOB NO.: 22-060	WEST END NORTHWEST LEUE AVE. navd88 =	WEST END OF CURB RETURNORTHWEST CORNER OF HEUE AVE.  navd88 = 236.11  navd29 = 233.49





TER NEW
ON
DISTRICT

/ALE COMMUNITY CENTER RKING LOT CONNECTION ALE RECREATION AND PARK DISTE

NOTE


Ξ Ш


()


OKAN

SHFFT NO.

C0.2

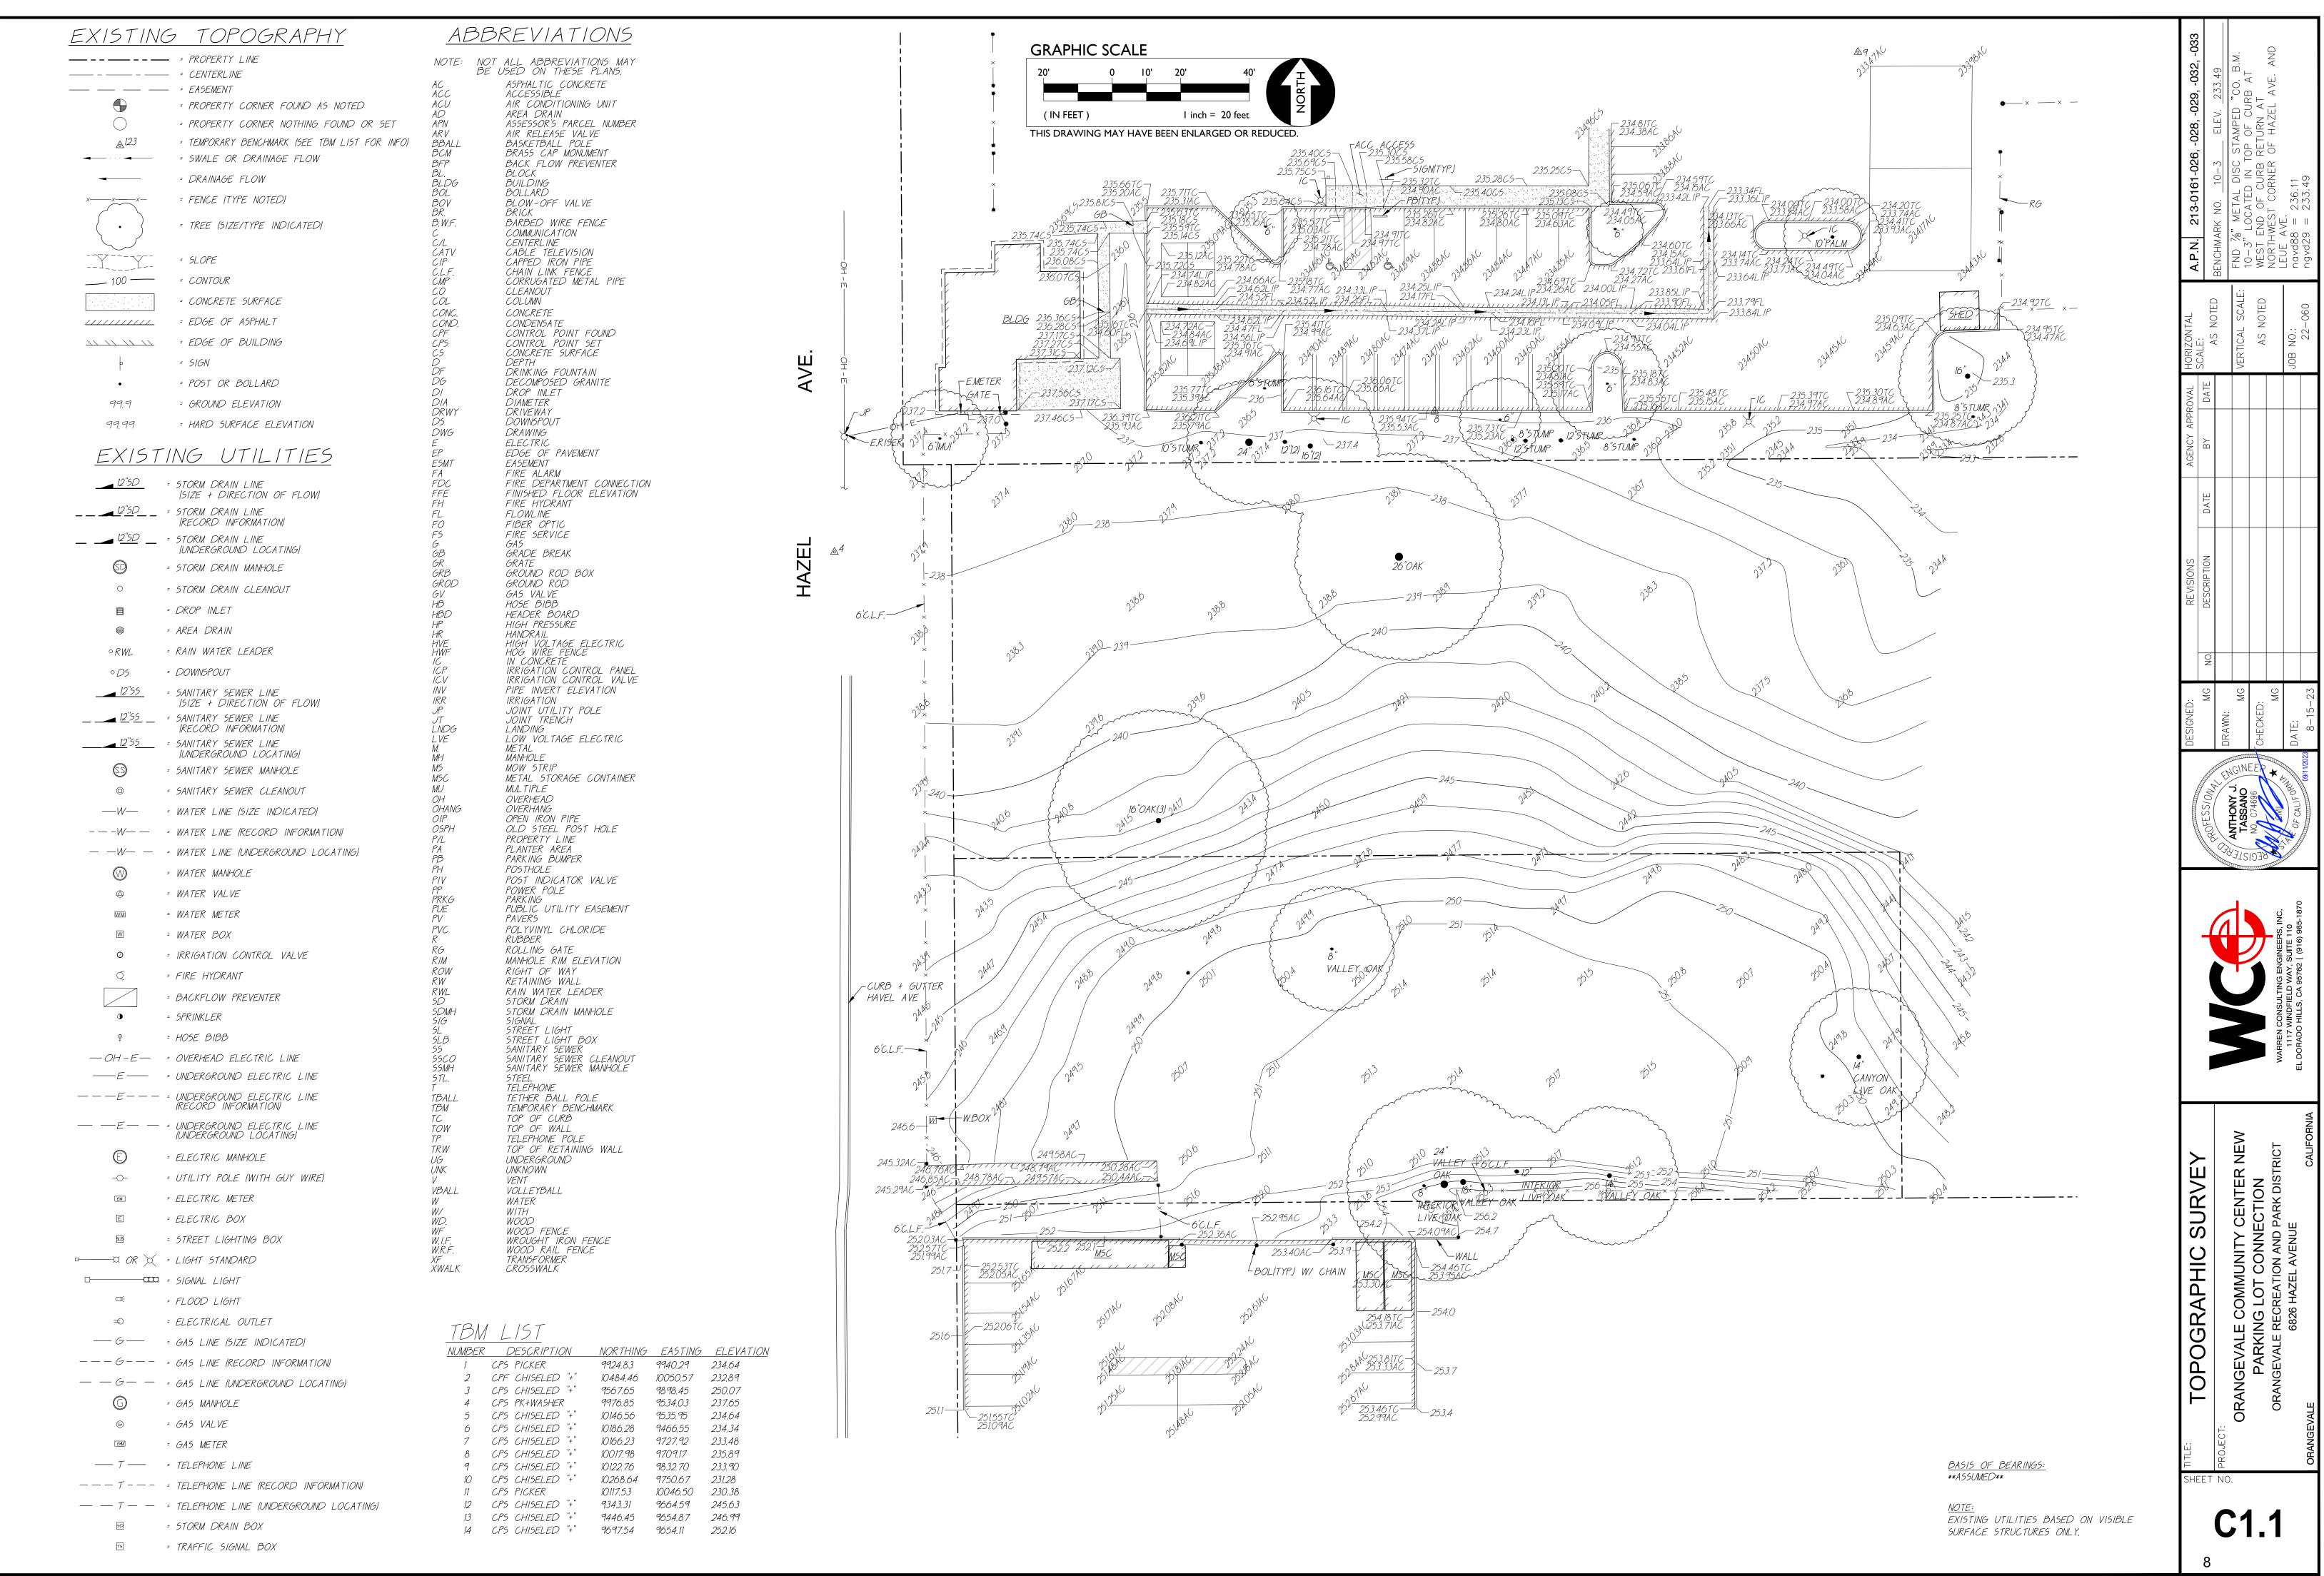

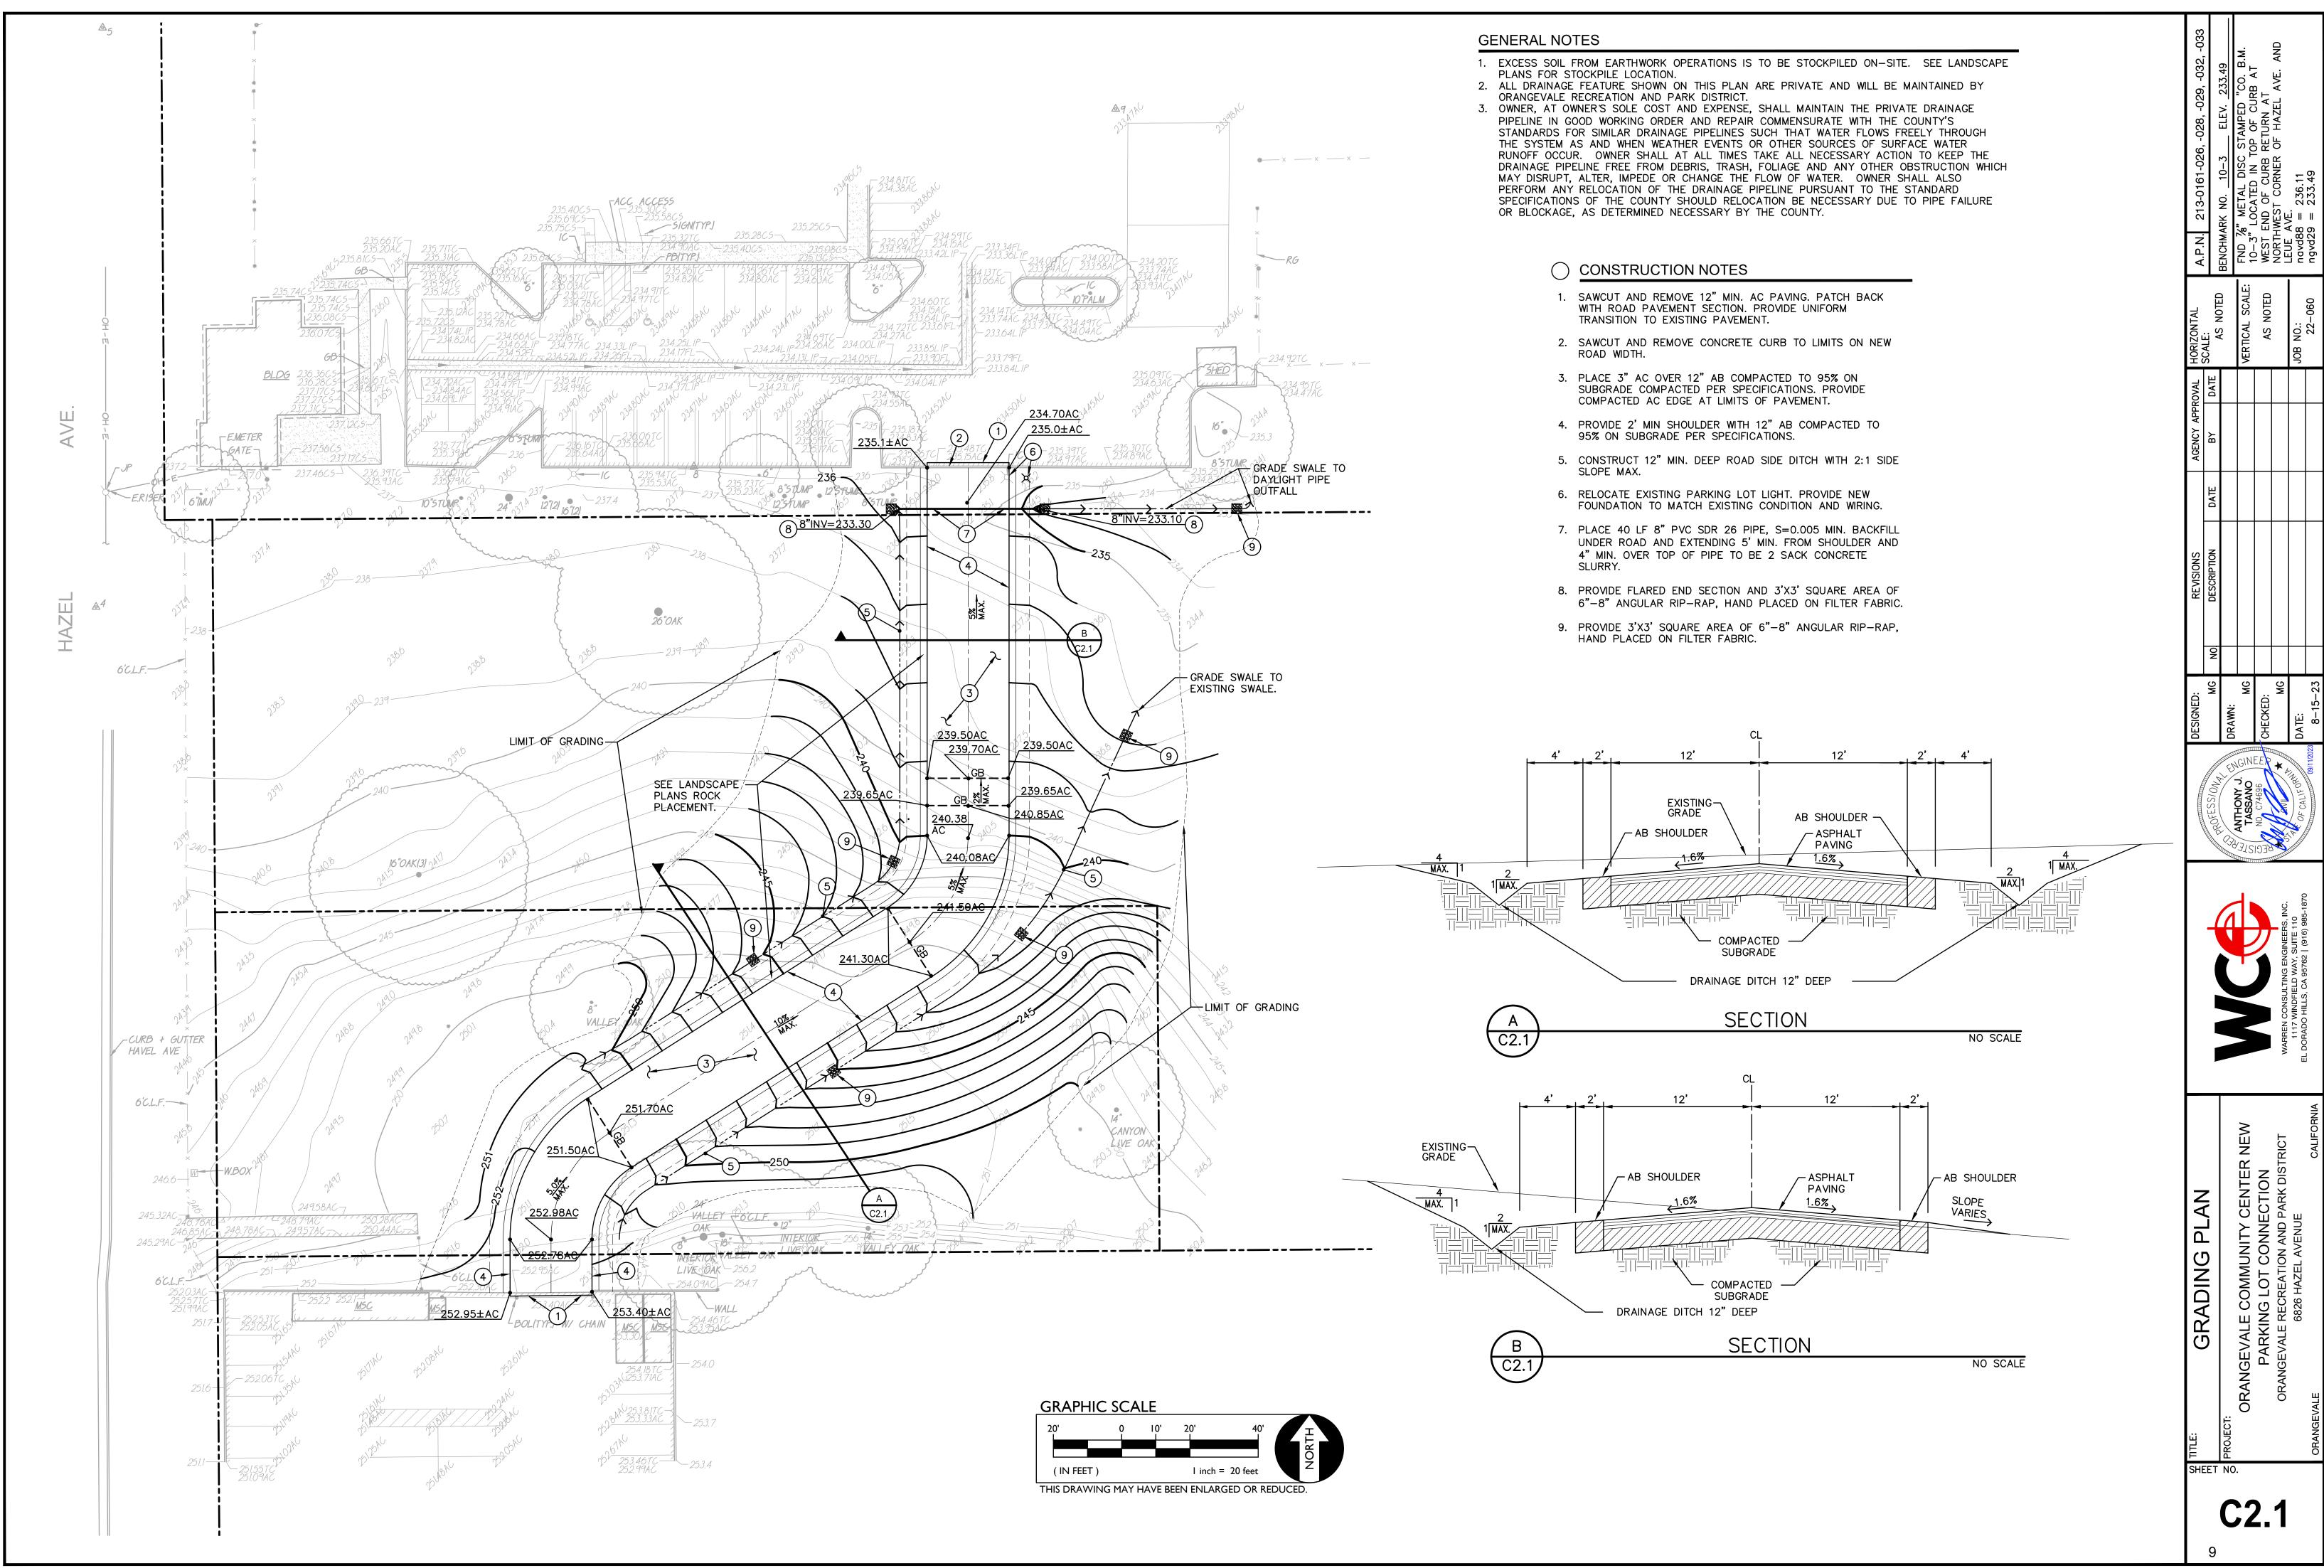

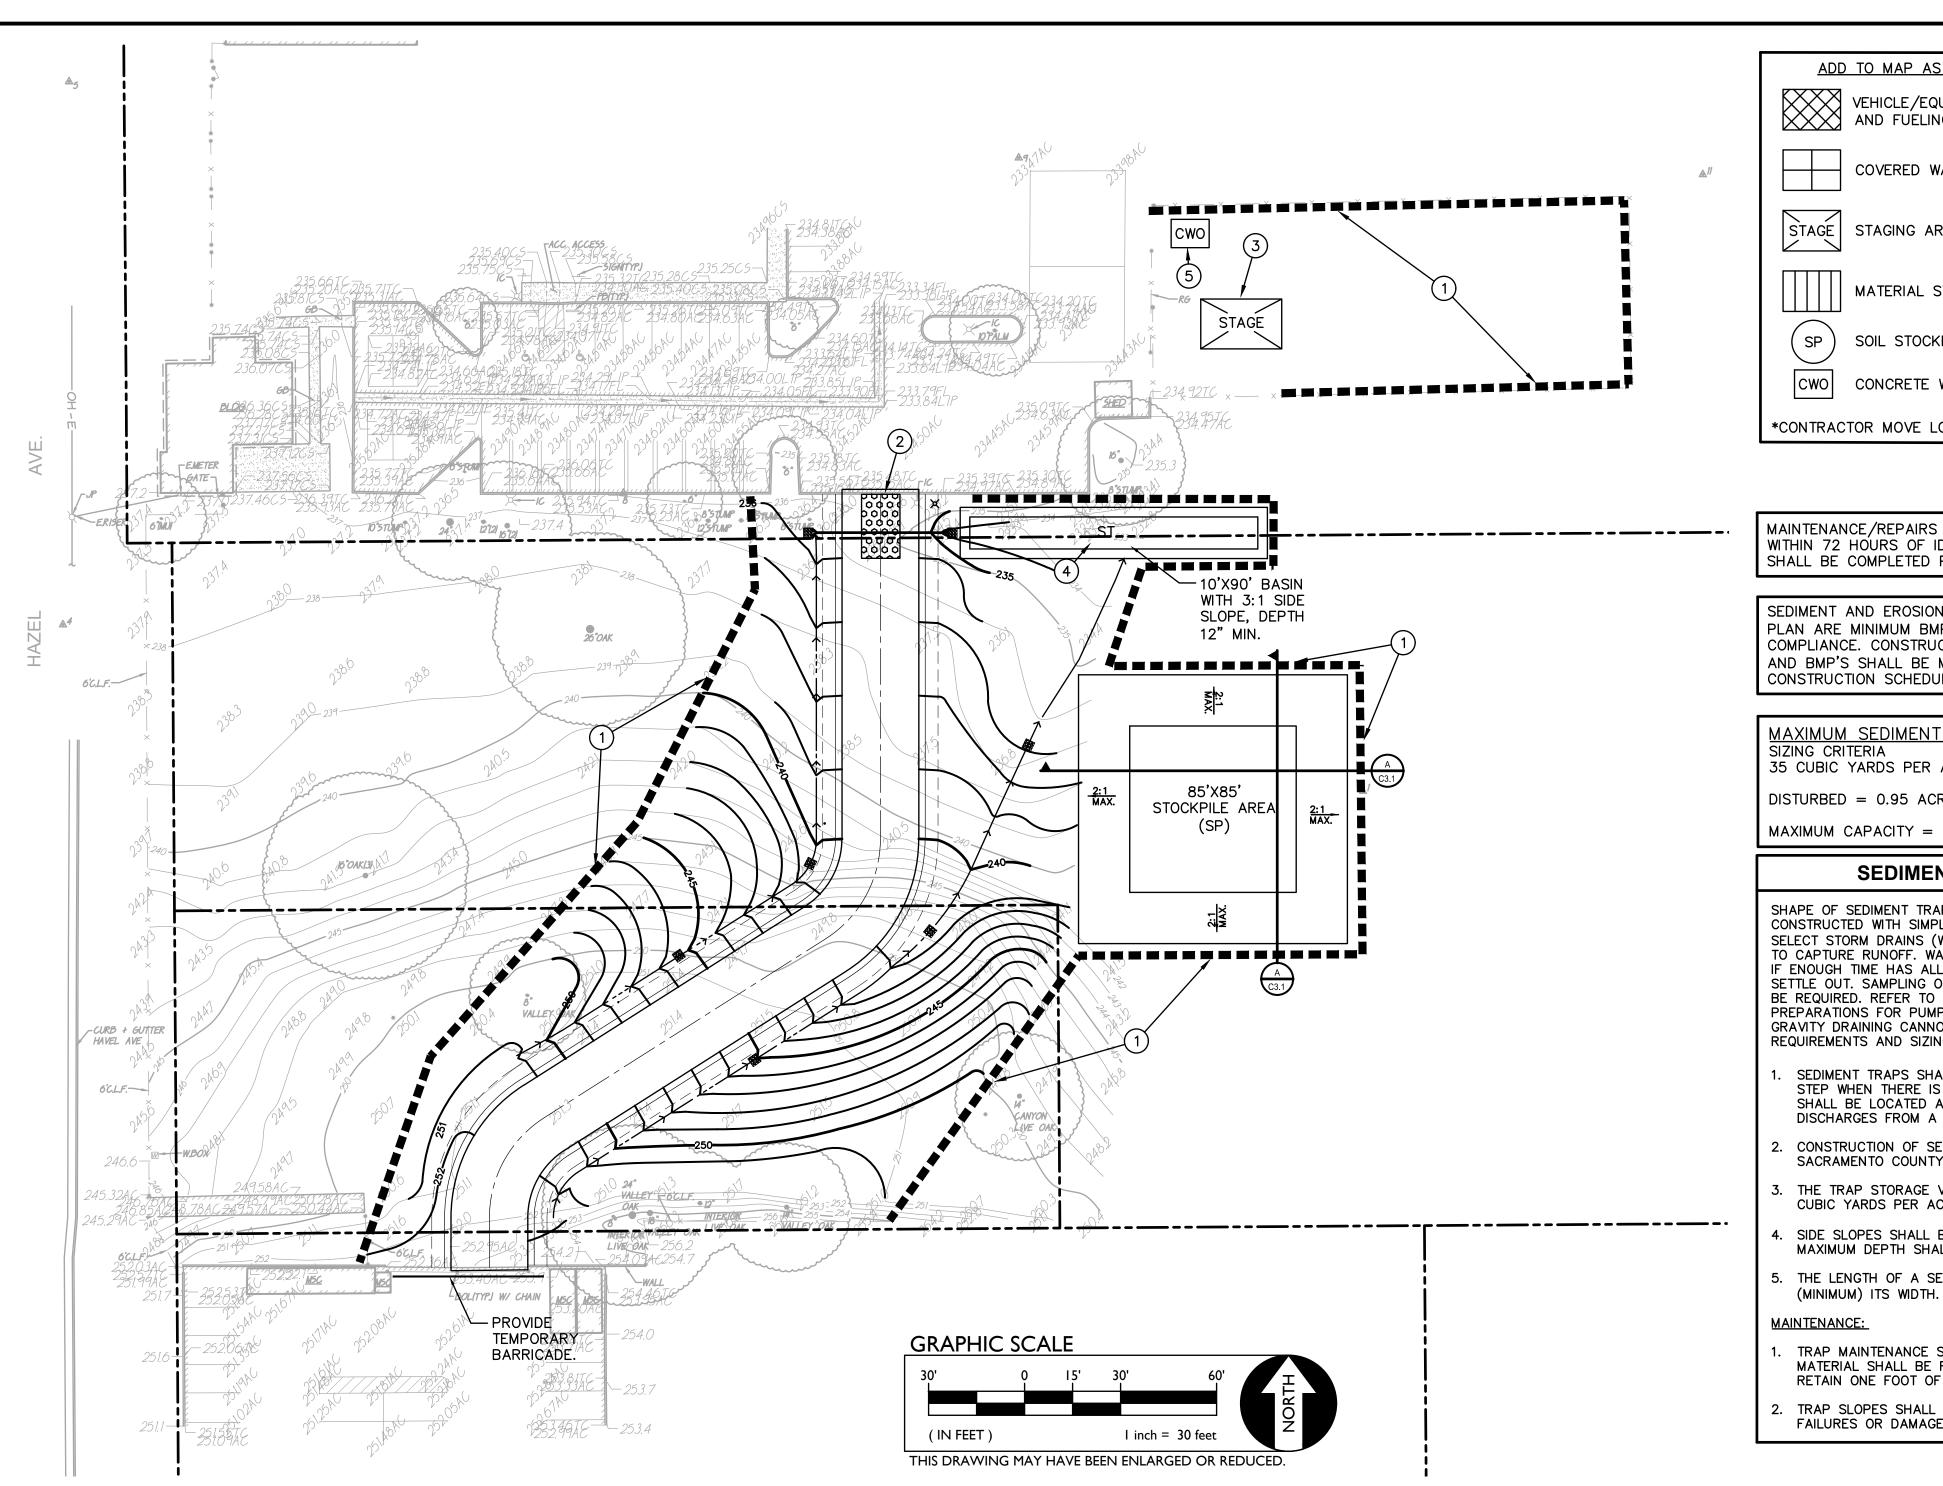

CONSTRUCTION

PRE-GRADING

**CUT-FILL ACTIVITIES** 

UNDERGROUND WORK

STORM IMPROVEMENT

CURB AND GUTTER

WET SEASON

HYDRO-SEEDING STRAW SOIL F MULCHING BINDERS

Χ

X

Χ

Χ

ADD TO MAP AS LOCATED IN THE FIELD VEHICLE/EQUIPMENT MAINTENANCE AND FUELING AREA. COVERED WASTE STORAGE (DUMPSTERS). STAGING AREA MATERIAL STORAGE SOIL STOCKPILES. CONCRETE WASHOUT.

MAINTENANCE/REPAIRS OF BMP FAILURE SHALL BEGIN WITHIN 72 HOURS OF IDENTIFICATION AND CHANGES SHALL BE COMPLETED PRIOR TO THE NEXT RAIN EVENT.

SEDIMENT AND EROSION CONTROL MEASURES ON THIS PLAN ARE MINIMUM BMP'S RECOMMENDED FOR COMPLIANCE. CONSTRUCTION SITE MUST BE MONITORED AND BMP'S SHALL BE MODIFIED DEPENDING ON CONSTRUCTION SCHEDULE AND RAIN EVENTS.

MAXIMUM SEDIMENT TRAP CAPACITY SIZING CRITERIA

MAXIMUM CAPACITY = 33.25 CUBIC YARDS

#### SEDIMENT TRAP NOTE

SHAPE OF SEDIMENT TRAPS CAN BE VARIABLE AND BE IF ENOUGH TIME HAS ALLOWED SEDIMENTS IN WATER TO BE REQUIRED. REFER TO SWPPP. CONTRACTOR SHALL MAKE PREPARATIONS FOR PUMPING AND FILTERING IN THE EVENT GRAVITY DRAINING CANNOT BE PERFORMED. SEE ADDITIONAL REQUIREMENTS AND SIZING LISTED BELOW:

- SHALL BE LOCATED AT THE POINT WHERE DRAINAGE DISCHARGES FROM A SITE AS NOTED ON PLANS.
- CONSTRUCTION OF SEDIMENT TRAPS SHALL BE PER SACRAMENTO COUNTY STANDARD DETAILS 11-2 AND 11-3
- THE TRAP STORAGE VOLUME SHALL BE DESIGNED FOR 33.2
- SIDE SLOPES SHALL BE 3:1 (H:V) OR FLATTER AND THE MAXIMUM DEPTH SHALL BE 3.5 FEET.
- 5. THE LENGTH OF A SEDIMENT TRAP SHALL BE 2 TIMES
- TRAP MAINTENANCE SHALL BE YEAR ROUND. SEDIMENT MATERIAL SHALL BE REMOVED FROM THE BOTTOM TO RETAIN ONE FOOT OF CAPACITY AT ALL TIMES.
- FAILURES OR DAMAGE SHALL BE REPAIRED PROMPTLY.

\*CONTRACTOR MOVE LOCATION IN FIELD AS NEEDED

35 CUBIC YARDS PER ACRE OF DISTURB AREA

DISTURBED = 0.95 ACRES

CONSTRUCTED WITH SIMPLE GRADED BERMS OR PLUGGING OF SELECT STORM DRAINS (WHICH WILL NOT CREATE A HAZARD) TO CAPTURE RUNOFF. WATER MAY BE RELEASED FROM BASINS SETTLE OUT. SAMPLING OF WATER PRIOR TO DISCHARGE MAY

- SEDIMENT TRAPS SHALL BE CONSTRUCTED AS THE FIRST STEP WHEN THERE IS MASS CLEARING OR GRADING AND
- CUBIC YARDS PER ACRE OF CONTRIBUTING DRAINAGE AREA

#### **MAINTENANCE:**


- TRAP SLOPES SHALL BE KEPT IN GOOD REPAIR. SLOPE

# # GENERAL EROSION CONTROL NOTES NOTE: EXACT LOCATION WILL BE COORDINATED BY

CONTRACTOR AND COUNTY OFFICIALS.

1. CONTRACTOR SHALL PROVIDE STRAW WATTLES AT PERIMETER OF SITE DISTURBED AREA PER SACRAMENTO COUNTY IMPROVEMENT STANDARDS, SECTION 11, AND STANDARD DRAWING 11-4.

CONTRACTOR SHALL PROVIDE STABILIZED CONSTRUCTION SITE ACCESS PER THE SACRAMENTO COUNTY IMPROVEMENT STANDARDS SECTION 11, AND STANDARD DRAWING 11-1.

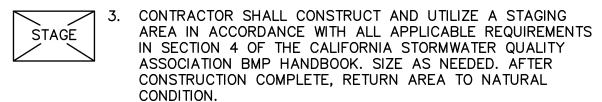

CONTRACTOR SHALL CONSTRUCT SEDIMENT TRAP VEGETATED OUTLET PER SACRAMENTO COUNTY STANDARDS DETAIL 11-2 TO TEMPORARILY CAPTURE STORM WATER DURING RAIN EVENTS SO IT CAN BE FILTERED AND DISCHARGED, OR SEDIMENT ALLOWED TO SETTLE-OUT PRIOR TO DISCHARGE.

CONTRACTOR SHALL CONSTRUCT AND UTILIZE A CONCRETE WASH-OUT IN ACCORDANCE WITH THE SACRAMENTO COUNTY IMPROVEMENT STANDARDS SECTION 11, AND

#### FINAL STABILIZATION NOTE

STANDARD DRAWING 11-6

ALL DISTURBED AREAS, WHICH ARE NOT PAVED OR SURFACED AS PART OF THESE PLANS, OR LANDSCAPED AS PART OF THE LANDSCAPE PLANS. EVEN THOSE AREAS NOT SHOWN TO BE DISTURBED BY THIS SET OF PLANS BUT ARE OTHERWISE DISTURBED BY CONSTRUCTION OR ACCESS BY EQUIPMENT, SHALL BE STABILIZED BY ONE OF THE FOLLOWING METHODS:

- HYDROSEED (ACCEPTABLE ONLY IF SUFFICIENT TIME IS PRESENT TO ENSURE VEGETATION ESTABLISHMENT PRIOR TO RAIN EVENTS.)
- 2. HYDROSEED WITH EROSION CONTROL BLANKETS OR
- 3. STRAW MULCH WITH SOIL BINDERS.
- METHODS MAY BE APPROVED BY THE COUNTY AFTER REVIEW WITH COUNTY INSPECTOR.

1,900± CY

100± CY

#### **EARTHWORK INFORMATION**

EST. CUT QUANTITY EST. FILL QUANTITY NET CUT/FILL 2,000± CY (CUT)


THE ABOVE PROVIDE VALUES ARE PROVIDED FOR PLAN CHECKING PURPOSES ONLY. IT IS NOT TO BE USED FOR BIDDING PURPOSES. THE CONTRACTOR SHALL PREPARE HIS/HER OWN CALCULATION OF EARTHWORK QUANTITIES FOR USE IN BID.

IF EXCESS MATERIAL IS GENERATED BY THE GRADING PROCESS THE CONTRACTOR IS TO DISPOSE OF EXCESS MATERIAL AT A SUITABLE SITE WHICH IS APPROVED BY THE COUNTY OF SACRAMENTO PROJECT INSPECTOR.

#### MONITORING SCHEDULE

- WITHIN 2 BUSINESS DAYS (48 HOURS) PRIOR TO EACH QUALIFYING RAIN EVÈNT.
- 2. EVERY 24 HOURS DURING A QUALIFYING RAIN EVENT
- 3. WITHIN 2 BUSINESS DAYS (48 HOURS) AFTER EACH QUALIFYING RAIN EVENT RESULTING IN 0.50 INCHES OF RAIN OR MORE.
- 4. RECORD THE TIME, DATE AND RAIN GAUGE READING OF ALL QUALIFYING RAIN EVENTS.
- 5. QUARTERLY NON-STORM WATER DISCHARGE INSPECTIONS.
- 6. WEEKLY INSPECTIONS.

MATERIAL & VASTE DISPOSAL LOCATION	CONCRETE WASHOUT	1
Χ		
Χ	X	
Χ	X	
Χ	Х	1 MAX.
Χ	X	1  MAX.
	Х	
Χ	Х	
		$\begin{pmatrix} A \\ C3.1 \end{pmatrix}$
		C3.1)
		•

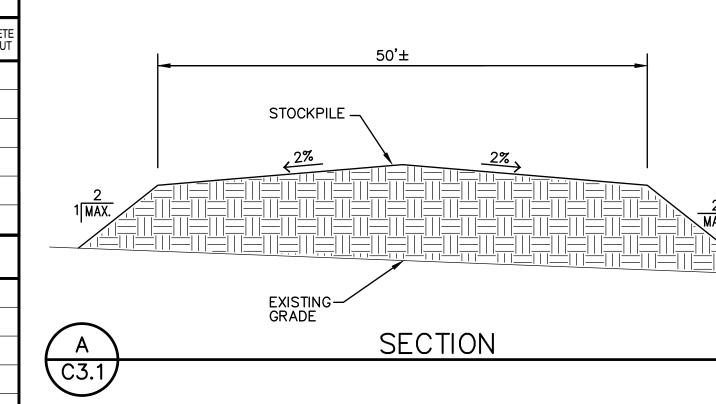

NO SCALE

CONTROL ROSION

# COUNTY OF SACRAMENTO EROSION AND SEDIMENT CONTROL GENERAL NOTES

1. ALL EROSION AND SEDIMENT CONTROL MEASURES SHALL BE CONSTRUCTED AND MAINTAINED IN ACCORDANCE WITH THE CURRENT EDITION OF THE COUNTY OF SACRAMENTO IMPROVEMENT STANDARDS.

2. EROSION CONTROL BEST MANAGEMENT PRACTICES (BMPS) SHALL BE INSTALLED AND MAINTAINED DURING THE WET

SEASON (OCTOBER 1 THROUGH APRIL 30). SEDIMENT CONTROL BMPS SHALL BE INSTALLED AND MAINTAINED YEAR

- 3. ALL DRAINAGE INLETS IMMEDIATELY DOWNSTREAM OF THE WORK AREAS AND WITHIN THE WORK AREAS SHALL BE PROTECTED WITH SEDIMENT CONTROL YEAR ROUND. INLET PROTECTION SHALL BE REMOVED FROM THE DRAINAGE INLETS UPON ACCEPTANCE OF THE PUBLIC IMPROVEMENTS BY THE COUNTY.
- 4. ALL STABILIZED CONSTRUCTION ACCESS LOCATIONS SHALL BE CONSTRUCTED PER STANDARD DRAWING 11-1 WHERE CONSTRUCTION TRAFFIC ENTERS OR LEAVES PAVED AREAS. THE STABILIZED ACCESS SHALL BE MAINTAINED ON A YEAR ROUND BASIS UNTIL THE COMPLETION OF CONSTRUCTION.
- 5. ALL AREAS DISTURBED DURING CONSTRUCTION BY GRADING, TRENCHING, OR OTHER ACTIVITIES, SHALL BE PROTECTED FROM EROSION DURING THE WET SEASON (OCTOBER 1 THROUGH APRIL 30). HYDROSEED, IF UTILIZED, MUST BE PLACED BY SEPTEMBER 15. HYDROSEED PLACED DURING THE WET SEASON SHALL USE A SECONDARY EROSION PROTECTION METHOD.
- 6. SENSITIVE AREAS AND AREAS WHERE EXISTING VEGETATION IS BEING PRESERVED SHALL BE PROTECTED WITH CONSTRUCTION FENCING. SEDIMENT CONTROL BMPS SHALL BE INSTALLED WHERE ACTIVE CONSTRUCTION AREAS DRAIN INTO SENSITIVE OR PRESERVED VEGETATION AREAS.
- 7. SEDIMENT CONTROL BMPS SHALL BE PLACED ALONG THE PROJECT PERIMETER WHERE DRAINAGE LEAVES THE PROJECT. SEDIMENT CONTROL BMPS SHALL BE MAINTAINED YEAR ROUND UNTIL THE CONSTRUCTION IS COMPLETE OR THE DRAINAGE PATTERN HAS BEEN CHANGED AND NO LONGER LEAVES THE SITE.
- 8. EROSION AND SEDIMENT CONTROL MEASURES FOR THE PROJECT SHALL BE IN SUBSTANTIAL COMPLIANCE AT ALL TIMES WITH THE STORMWATER POLLUTION PREVENTION PLAN (SWPPP) PREPARED FOR THE PROJECT IN ACCORDANCE WITH THE STATE OF CALIFORNIA GENERAL CONSTRUCTION PERMIT. THIS PERMIT REQUIRES THAT THE SWPPP BE KEPT UP TO DATE TO REFLECT THE CHANGING SITE CONDITIONS AND THE SWPPP IS TO BE AVAILABLE ON SITE AT ALL TIMES FOR REVIEW STATE AND LOCAL INSPECTORS.
- 9. EFFECTIVE EROSION CONTROL BMPS SHALL BE IN PLACE PRIOR TO ANY STORM EVENTS.
- 10. IF COLLOIDAL SOILS ARE ENCOUNTERED, REMOVAL OF COLLOIDIAL SUSPENSIONS BY A COUNTY APPROVED METHOD BEFORE DISCHARGE IS REQUIRED.

PAVE OUT **MAINTENANCE** SCHEDULE  $X \mid X$ Χ WEEKLY\* Χ MONTHLY\* **BEFORE RAIN DURING RAIN**  $X \mid X$ AFTER RAIN AS NEEDED \* = WHEN RAIN EVENT INSPECTIONS OCCURS, THEY MAY QUALIFY AS A DAILY, WEEKLY, OR MONTHLY INSPECTION AS APPLIES.

| X

 $X \mid X$ 

 $X \mid X$ 

 $X \mid X$ 

| X

**EROSION AND SEDIMENT CONTROL MEASURES** 

PRESERVATION BLANKETS OF EXISTING WATS & GEOTEXTILES ROLLS CONTROL PROTECTION FENCING BAG BARRIERS PROTECTION SILT SAND/GRAVEL STORM DRAIN SEDIMENT TRAP DEWATERING CONSTRUCTION WENTRANCE

WET & DRY SEASON

N/A

Χ

Χ

Χ

Χ